
# UMA BANGOR CAMDEN HALL SECOND FLOOR RENOVATION

BANGOR, ME

ISSUED FOR BID 06/03/2022

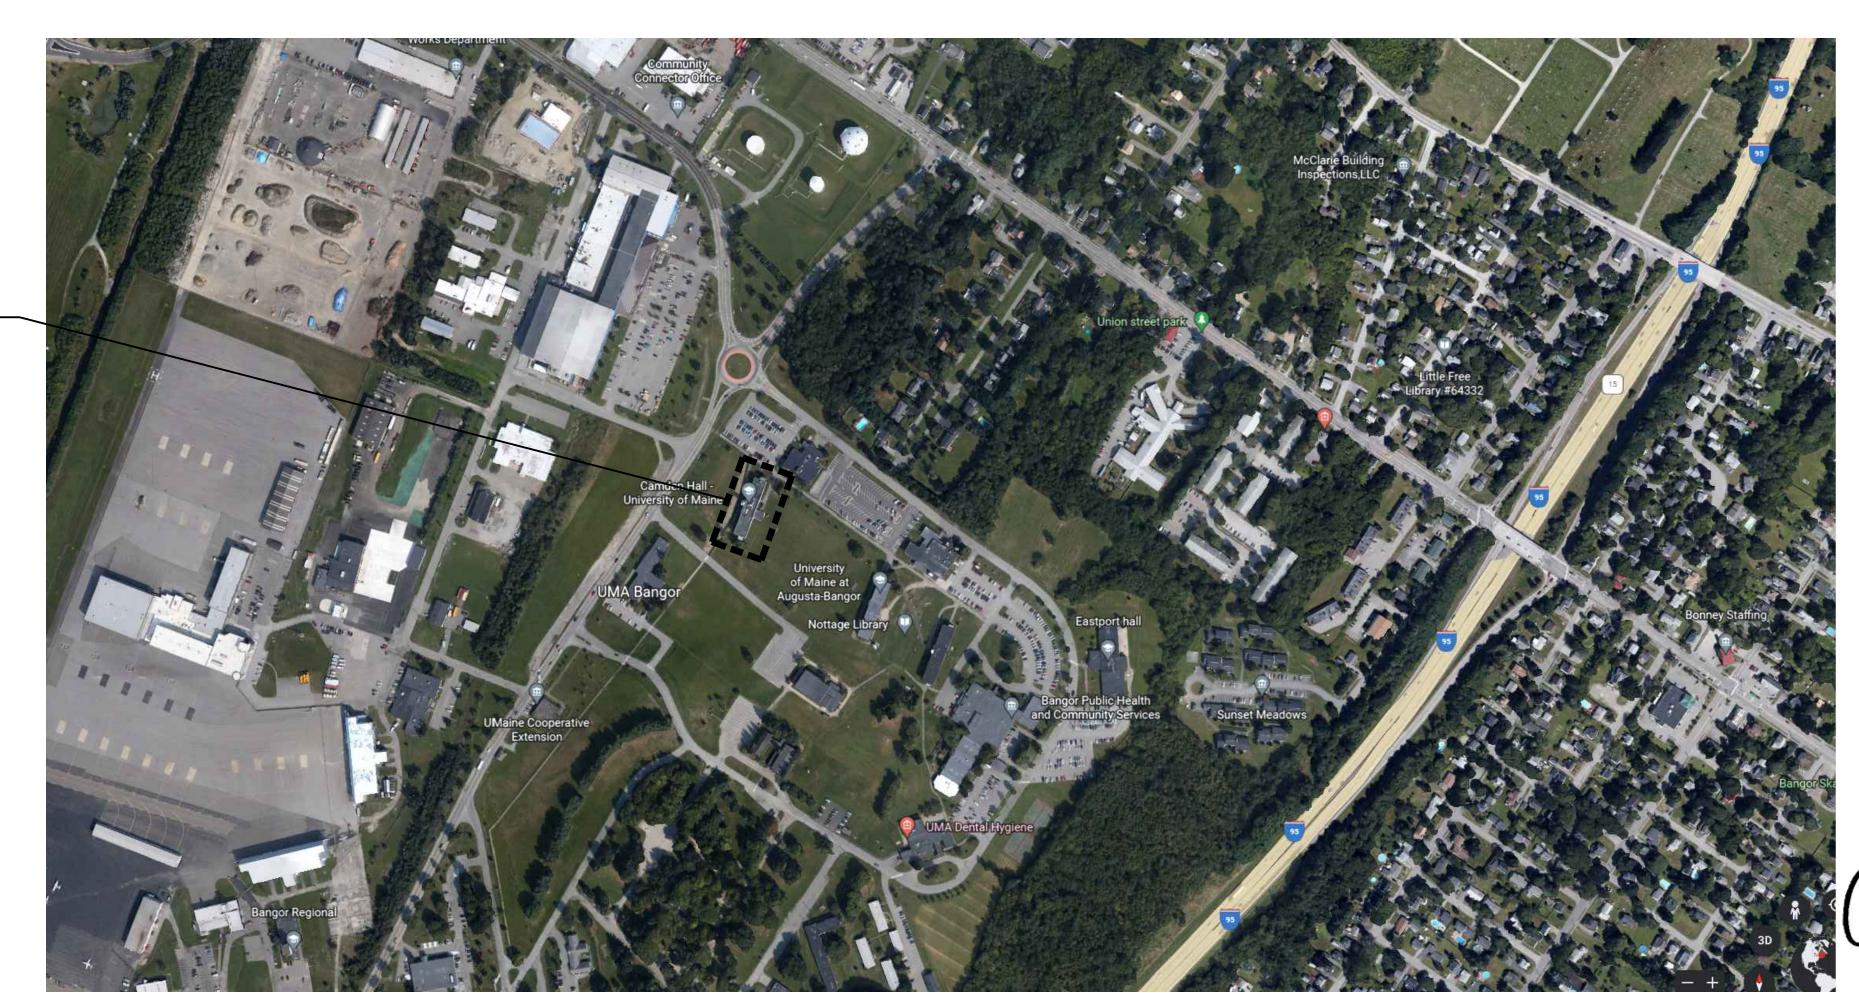

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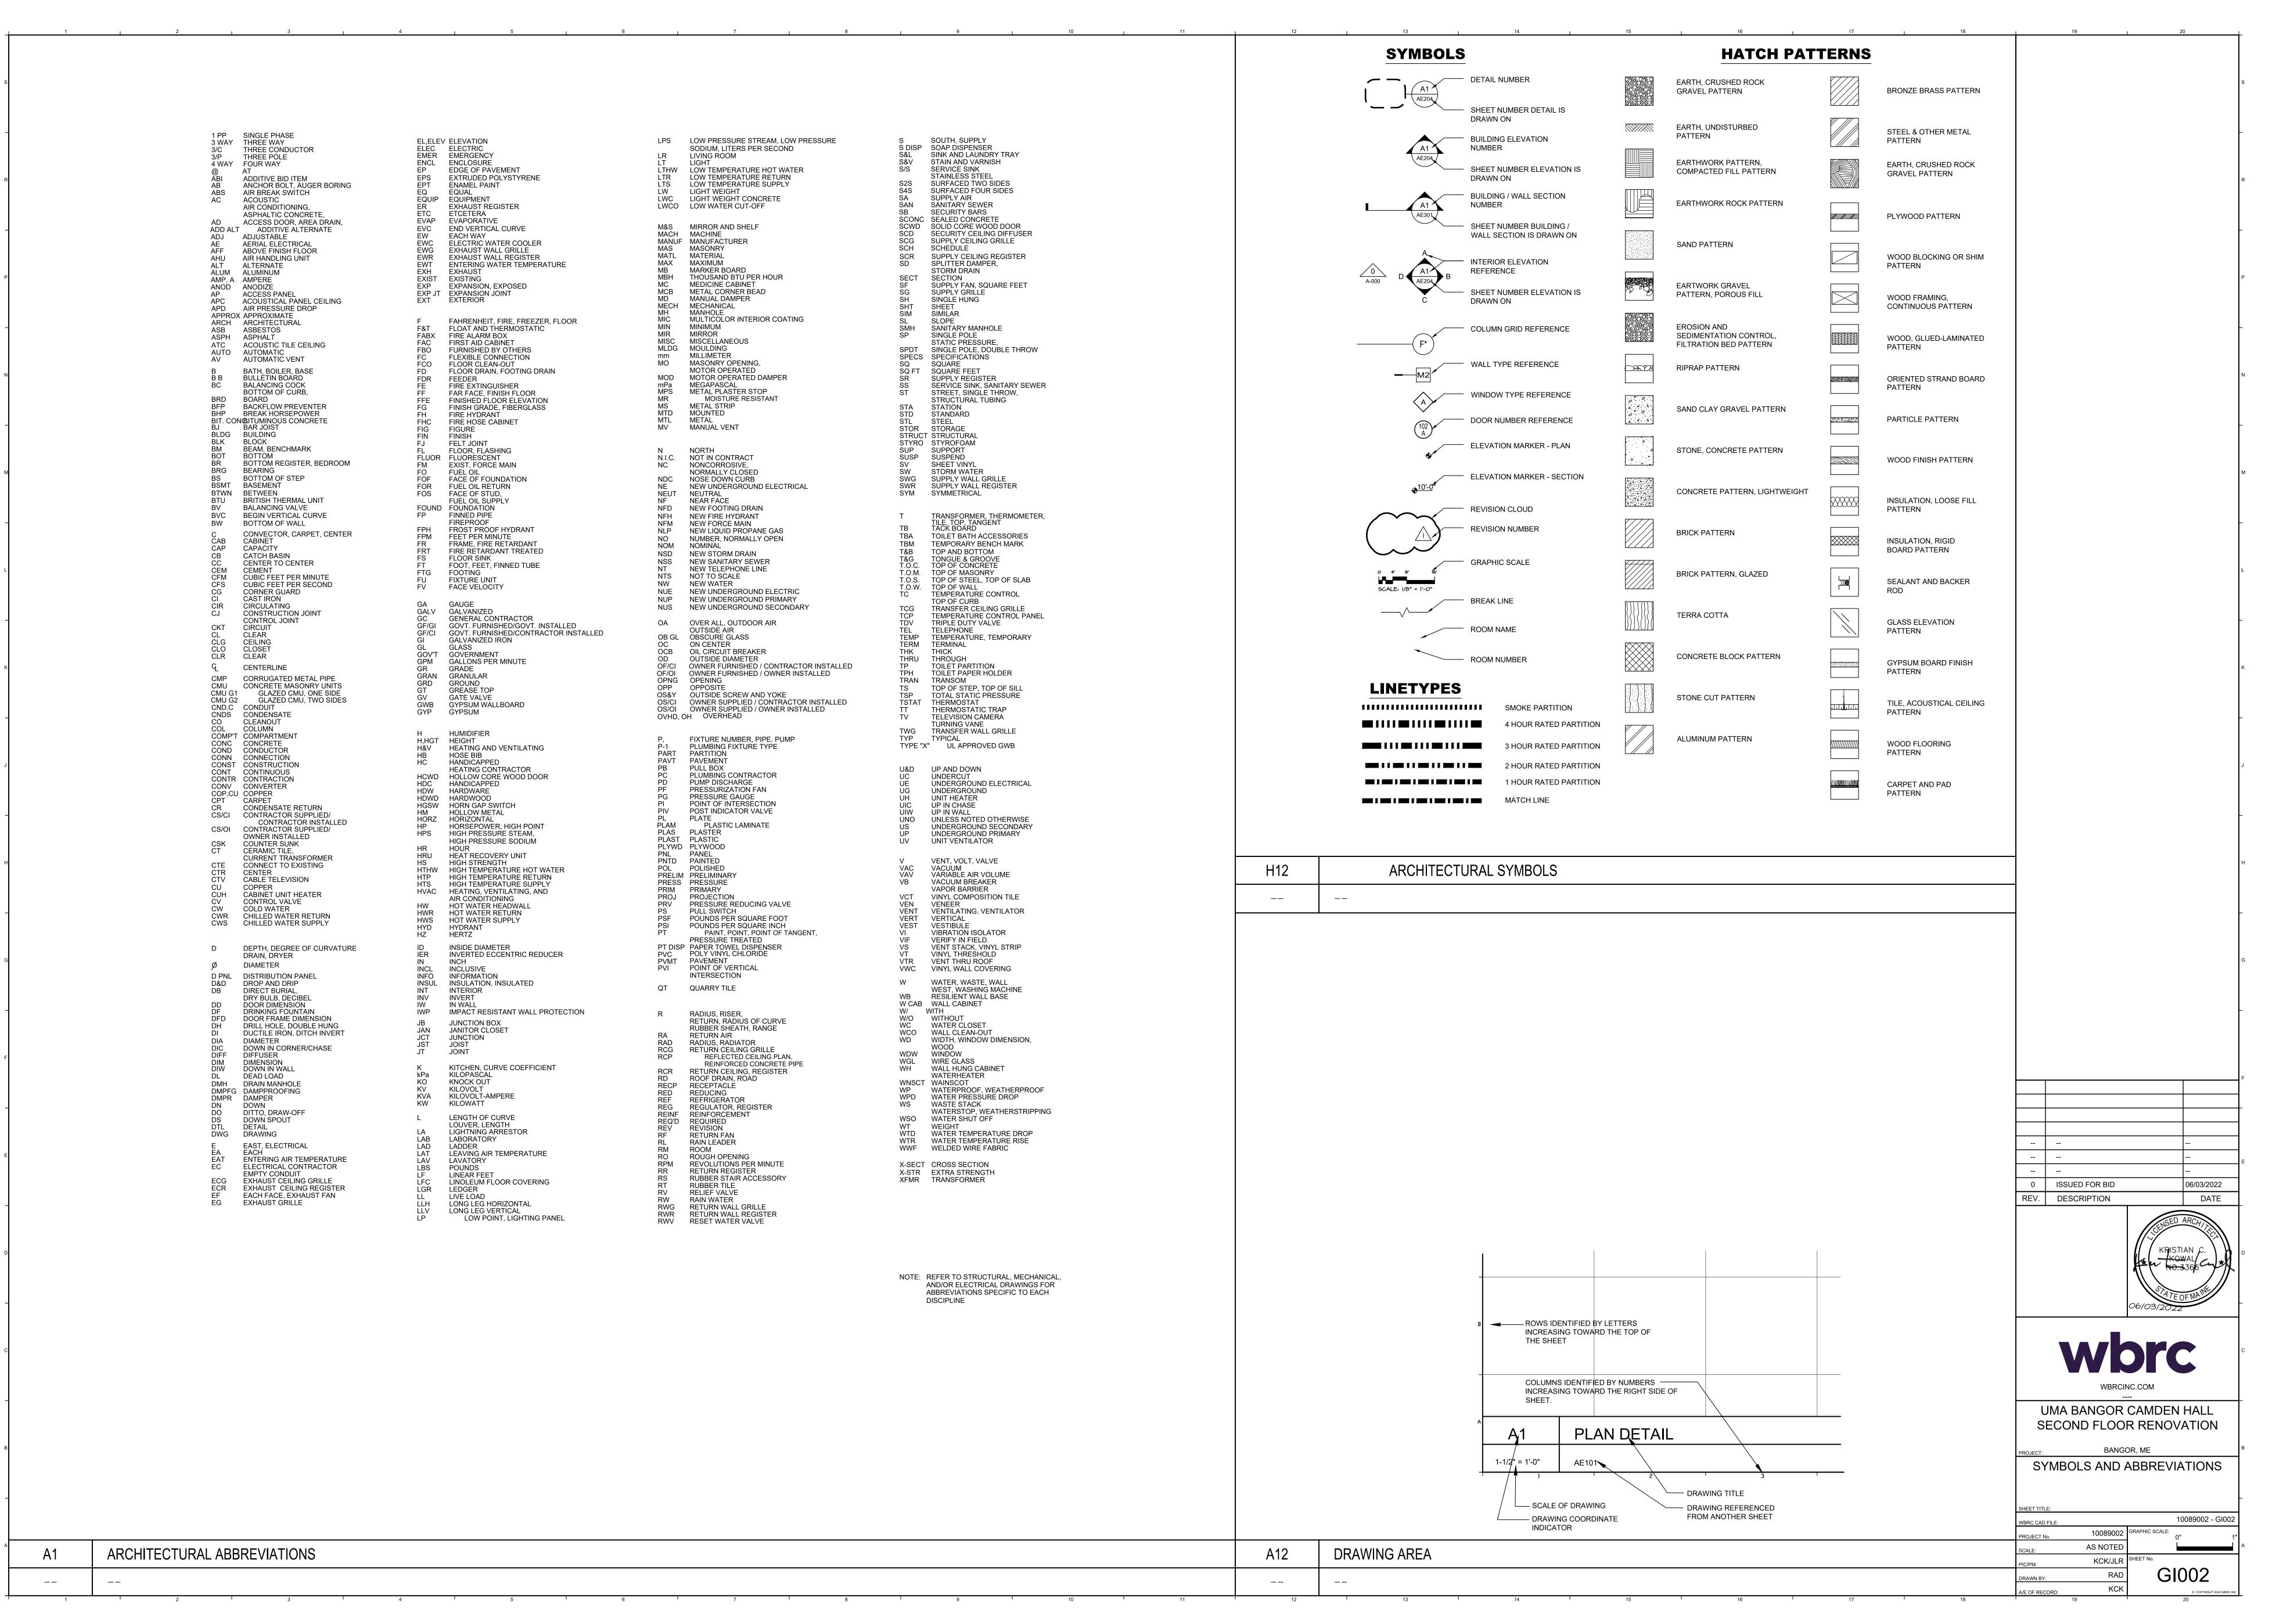
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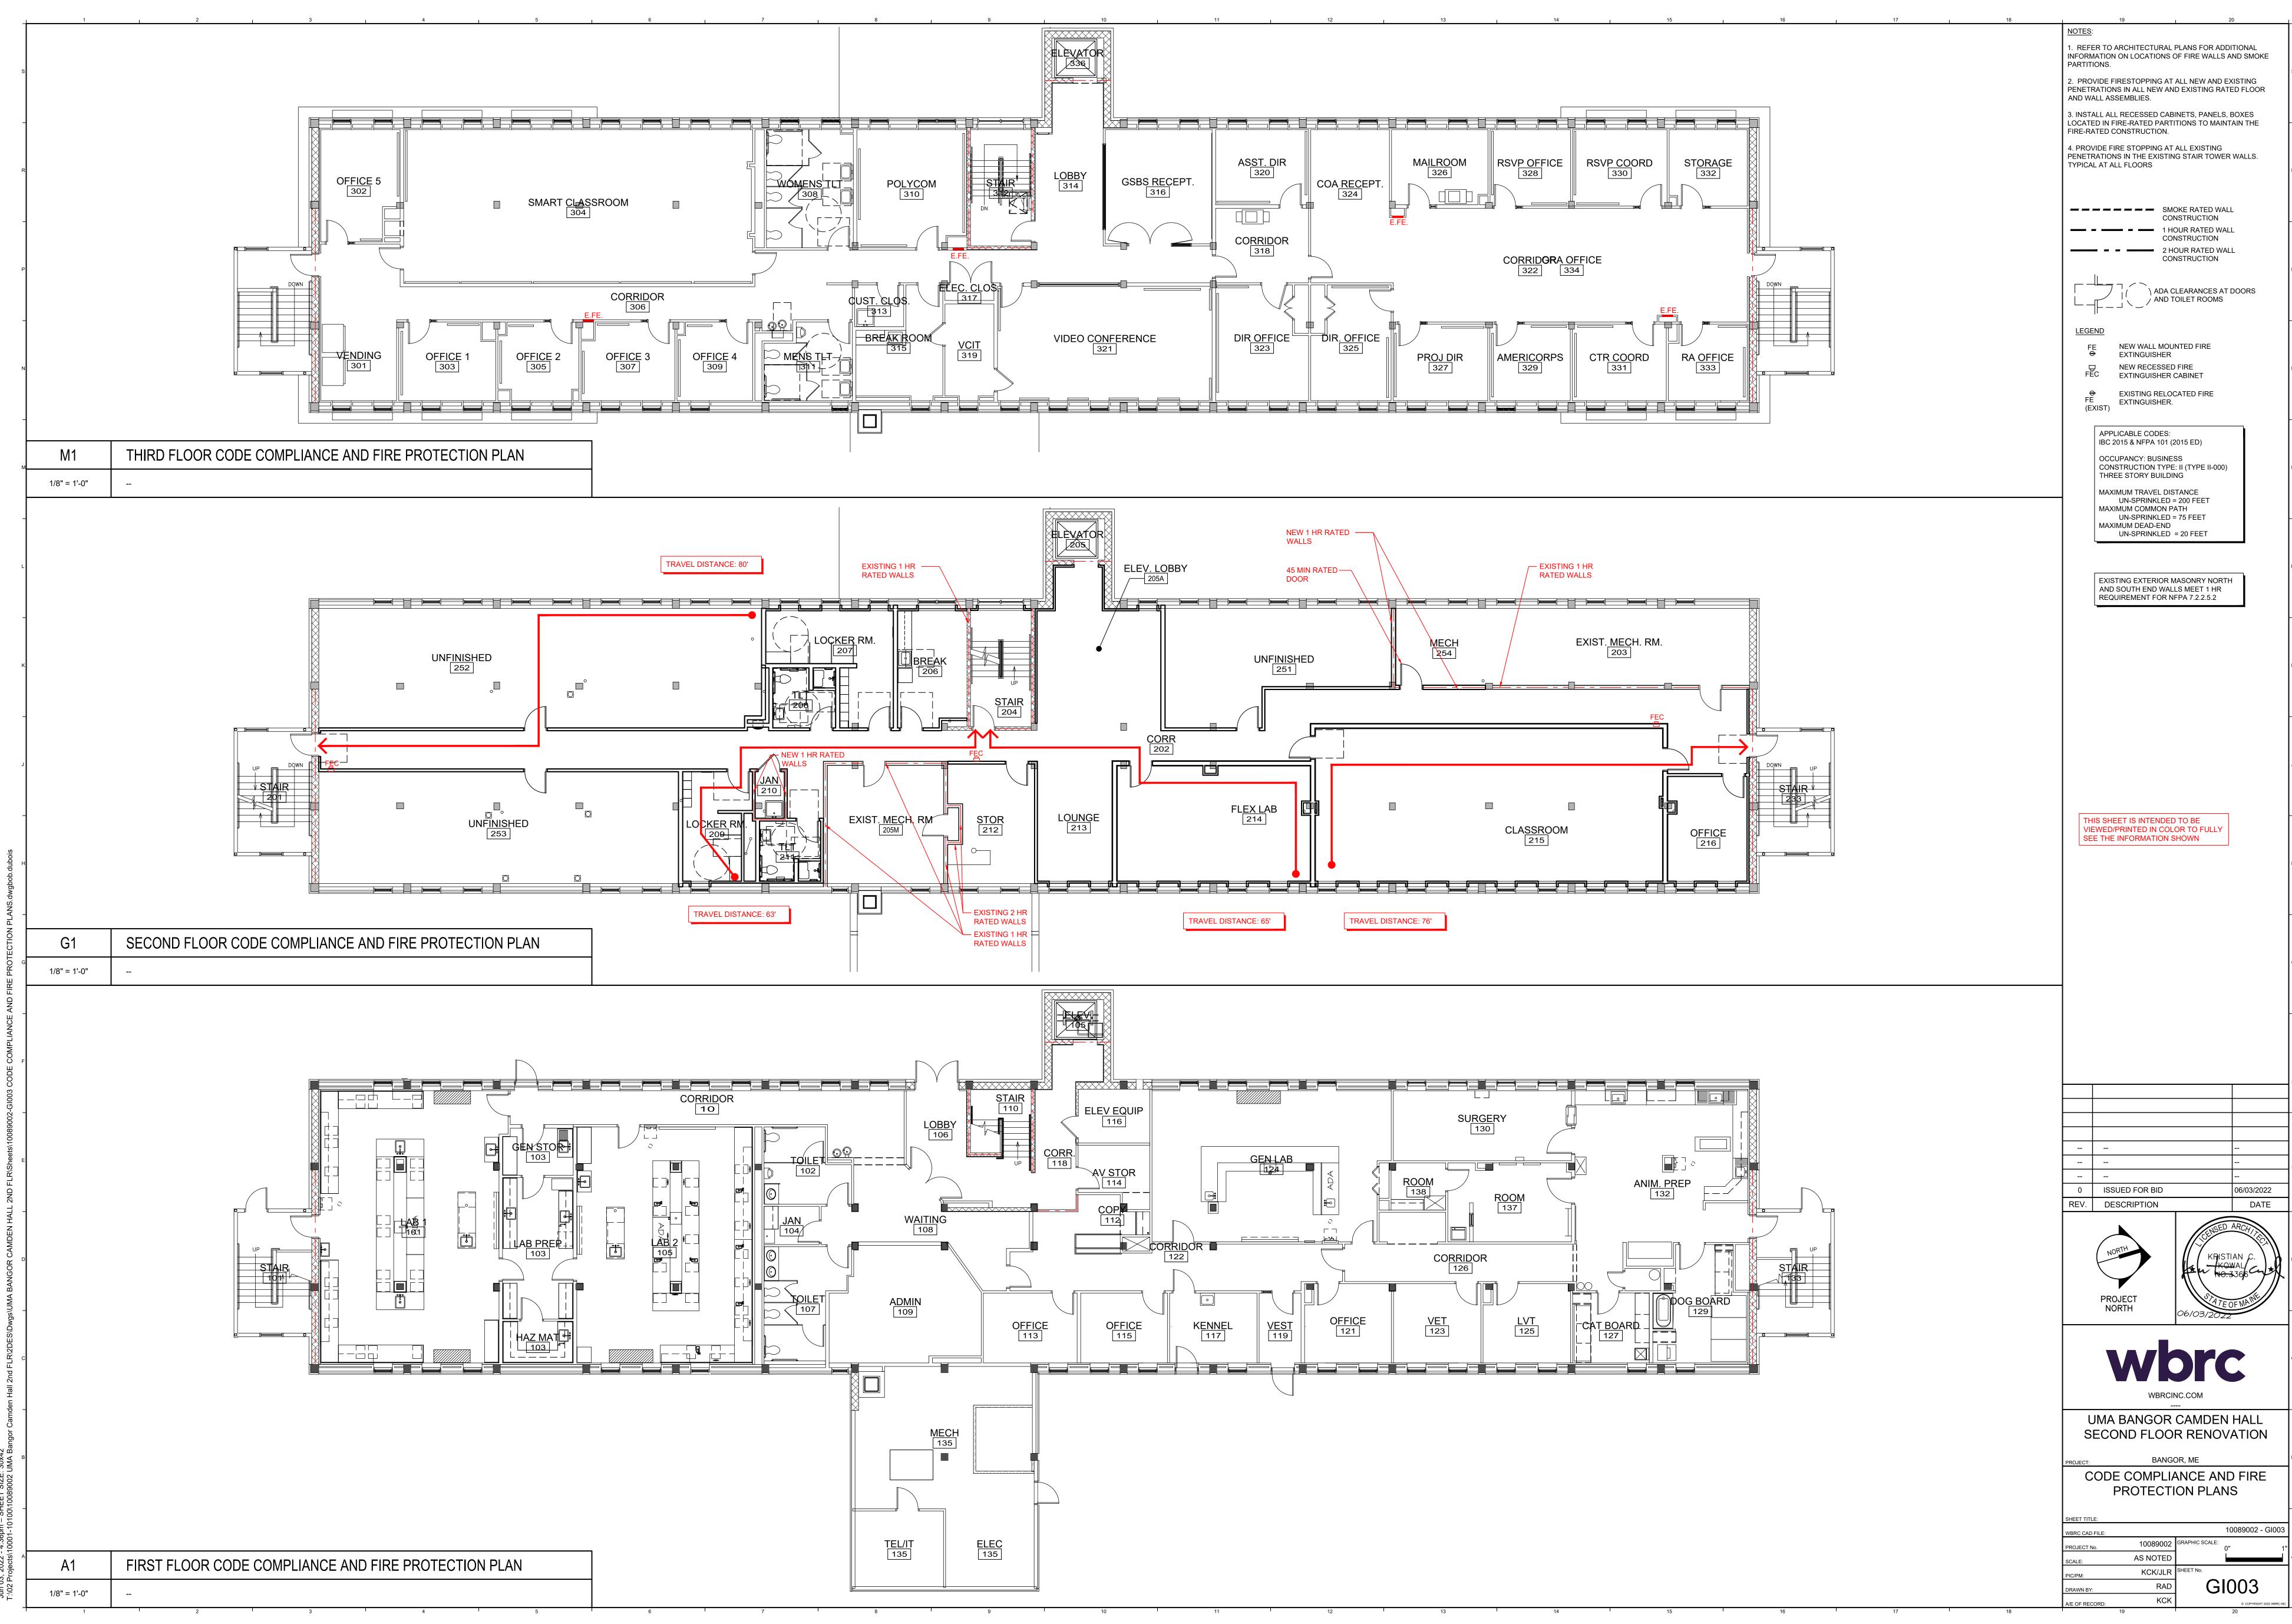
SHEET No. GI001

PROJECT No. 10089002




PROJECT SITE





Jun 03, 2022 - 4:36pm – SHEET SIZE: 30x

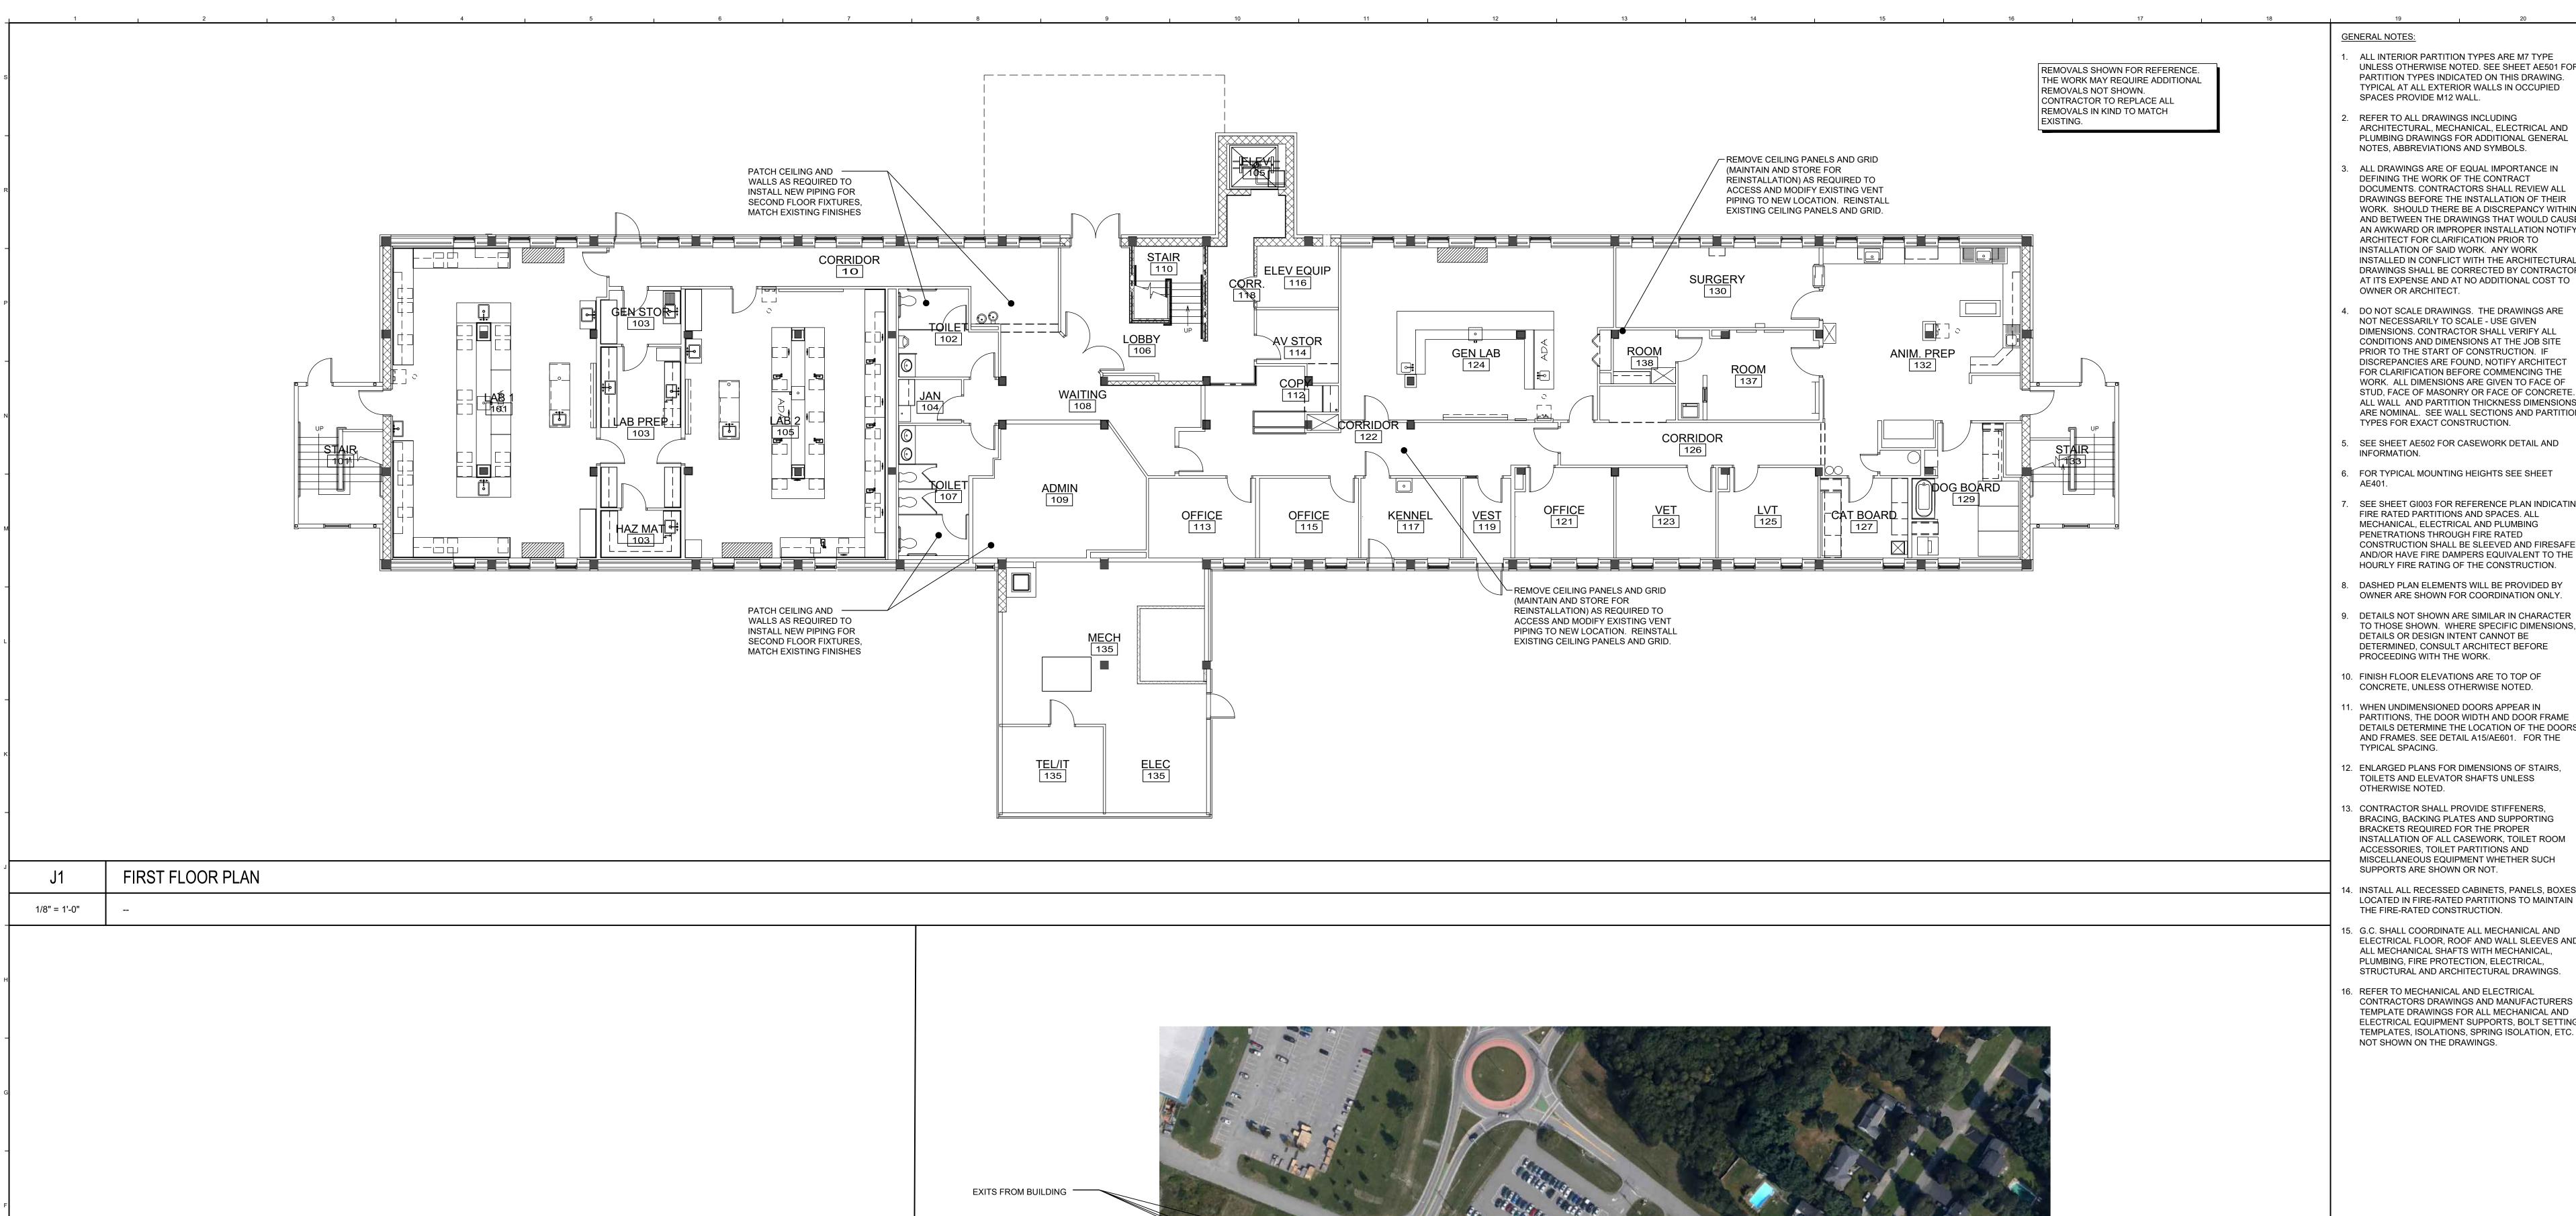

PROPOSED PRIMARY CONTRACTOR — ACCESS DOOR FOR BUILDING. MAINTAIN EMERGENCY EGRESS THROUGH PROJECT. PROPOSED PRIMARY PARKING FOR — CONTRACTOR FOR PROJECT PROPOSED PRIMARY LAYDOWN ---SPACE FOR CONTRACTOR. PROPOSED SECONDARY PARKING -FOR CONTRACTORS/SUBS FOR PROJECT.

**GENERAL NOTES:** 

. ALL INTERIOR PARTITION TYPES ARE M7 TYPE UNLESS OTHERWISE NOTED. SEE SHEET AE501 FOR PARTITION TYPES INDICATED ON THIS DRAWING. TYPICAL AT ALL EXTERIOR WALLS IN OCCUPIED SPACES PROVIDE M12 WALL.

2. REFER TO ALL DRAWINGS INCLUDING ARCHITECTURAL, MECHANICAL, ELECTRICAL AND PLUMBING DRAWINGS FOR ADDITIONAL GENERAL

NOTES, ABBREVIATIONS AND SYMBOLS.

ALL DRAWINGS ARE OF EQUAL IMPORTANCE IN DEFINING THE WORK OF THE CONTRACT DOCUMENTS. CONTRACTORS SHALL REVIEW ALL DRAWINGS BEFORE THE INSTALLATION OF THEIR WORK. SHOULD THERE BE A DISCREPANCY WITHIN AND BETWEEN THE DRAWINGS THAT WOULD CAUSE AN AWKWARD OR IMPROPER INSTALLATION NOTIFY ARCHITECT FOR CLARIFICATION PRIOR TO INSTALLATION OF SAID WORK. ANY WORK INSTALLED IN CONFLICT WITH THE ARCHITECTURAL DRAWINGS SHALL BE CORRECTED BY CONTRACTOR AT ITS EXPENSE AND AT NO ADDITIONAL COST TO OWNER OR ARCHITECT.

4. DO NOT SCALE DRAWINGS. THE DRAWINGS ARE NOT NECESSARILY TO SCALE - USE GIVEN DIMENSIONS. CONTRACTOR SHALL VERIFY ALL CONDITIONS AND DIMENSIONS AT THE JOB SITE PRIOR TO THE START OF CONSTRUCTION. IF DISCREPANCIES ARE FOUND, NOTIFY ARCHITECT FOR CLARIFICATION BEFORE COMMENCING THE WORK. ALL DIMENSIONS ARE GIVEN TO FACE OF STUD, FACE OF MASONRY OR FACE OF CONCRETE. ALL WALL AND PARTITION THICKNESS DIMENSIONS ARE NOMINAL. SEE WALL SECTIONS AND PARTITION TYPES FOR EXACT CONSTRUCTION.

5. SEE SHEET AE502 FOR CASEWORK DETAIL AND INFORMATION.

6. FOR TYPICAL MOUNTING HEIGHTS SEE SHEET

7. SEE SHEET GI003 FOR REFERENCE PLAN INDICATING FIRE RATED PARTITIONS AND SPACES. ALL MECHANICAL, ELECTRICAL AND PLUMBING PENETRATIONS THROUGH FIRE RATED CONSTRUCTION SHALL BE SLEEVED AND FIRESAFED AND/OR HAVE FIRE DAMPERS EQUIVALENT TO THE HOURLY FIRE RATING OF THE CONSTRUCTION.

8. DASHED PLAN ELEMENTS WILL BE PROVIDED BY OWNER ARE SHOWN FOR COORDINATION ONLY.

DETAILS OR DESIGN INTENT CANNOT BE DETERMINED, CONSULT ARCHITECT BEFORE PROCEEDING WITH THE WORK. 10. FINISH FLOOR ELEVATIONS ARE TO TOP OF

TO THOSE SHOWN. WHERE SPECIFIC DIMENSIONS,

CONCRETE, UNLESS OTHERWISE NOTED.

11. WHEN UNDIMENSIONED DOORS APPEAR IN PARTITIONS, THE DOOR WIDTH AND DOOR FRAME DETAILS DETERMINE THE LOCATION OF THE DOORS AND FRAMES. SEE DETAIL A15/AE601. FOR THE TYPICAL SPACING.

12. ENLARGED PLANS FOR DIMENSIONS OF STAIRS, TOILETS AND ELEVATOR SHAFTS UNLESS OTHERWISE NOTED.


13. CONTRACTOR SHALL PROVIDE STIFFENERS, BRACING, BACKING PLATES AND SUPPORTING BRACKETS REQUIRED FOR THE PROPER INSTALLATION OF ALL CASEWORK, TOILET ROOM ACCESSORIES, TOILET PARTITIONS AND MISCELLANEOUS EQUIPMENT WHETHER SUCH SUPPORTS ARE SHOWN OR NOT.

14. INSTALL ALL RECESSED CABINETS, PANELS, BOXES LOCATED IN FIRE-RATED PARTITIONS TO MAINTAIN THE FIRE-RATED CONSTRUCTION.

15. G.C. SHALL COORDINATE ALL MECHANICAL AND ELECTRICAL FLOOR, ROOF AND WALL SLEEVES AND ALL MECHANICAL SHAFTS WITH MECHANICAL, PLUMBING, FIRE PROTECTION, ELECTRICAL, STRUCTURAL AND ARCHITECTURAL DRAWINGS.

16. REFER TO MECHANICAL AND ELECTRICAL CONTRACTORS DRAWINGS AND MANUFACTURERS TEMPLATE DRAWINGS FOR ALL MECHANICAL AND ELECTRICAL EQUIPMENT SUPPORTS, BOLT SETTING TEMPLATES, ISOLATIONS, SPRING ISOLATION, ETC. NOT SHOWN ON THE DRAWINGS.

ISSUED FOR BID 06/03/2022 REV. DESCRIPTION DATE

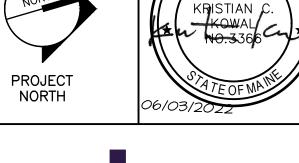

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UMA BANGOR CAMDEN HALL SECOND FLOOR RENOVATION


> BANGOR, ME FIRST FLOOR PLAN

10089002 GRAPHIC SCALE: AS NOTED


KCK/JLR SHEET No

10089002 - AE101

SITE REFRENCE PLAN N.T.S.

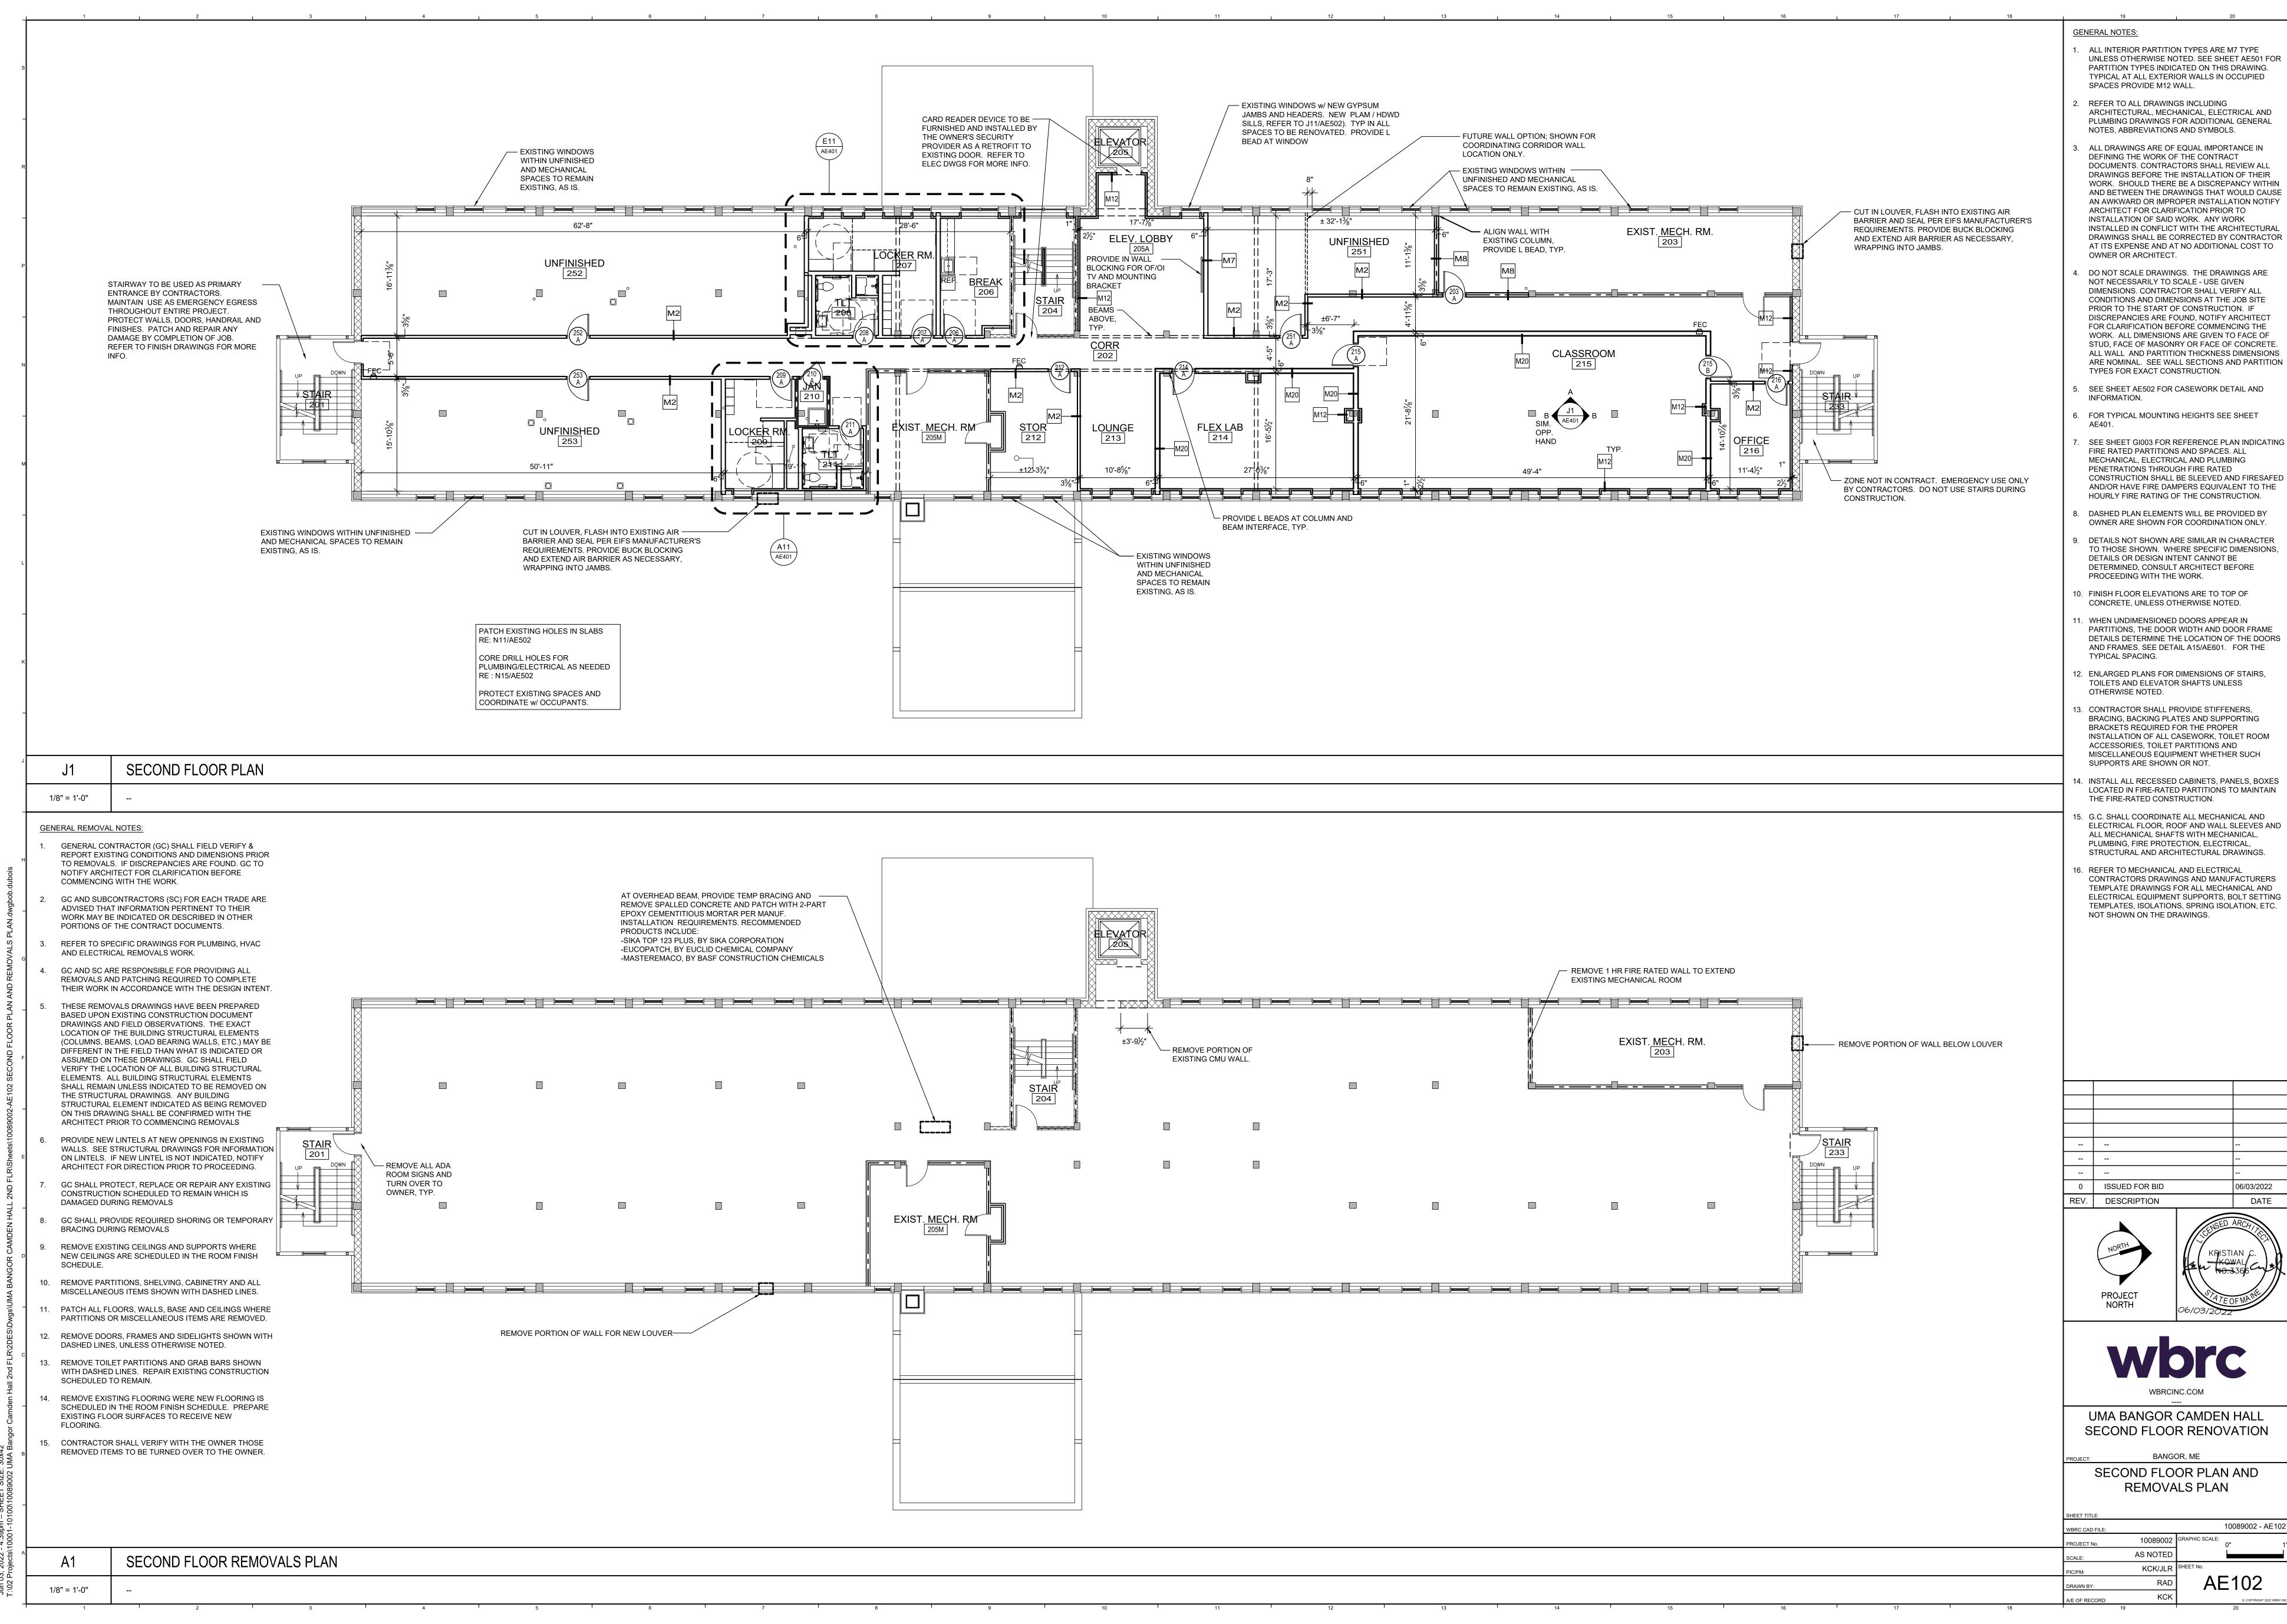

Jun 03, 2022 - 4:39pm – SHEET SIZE: 30x42

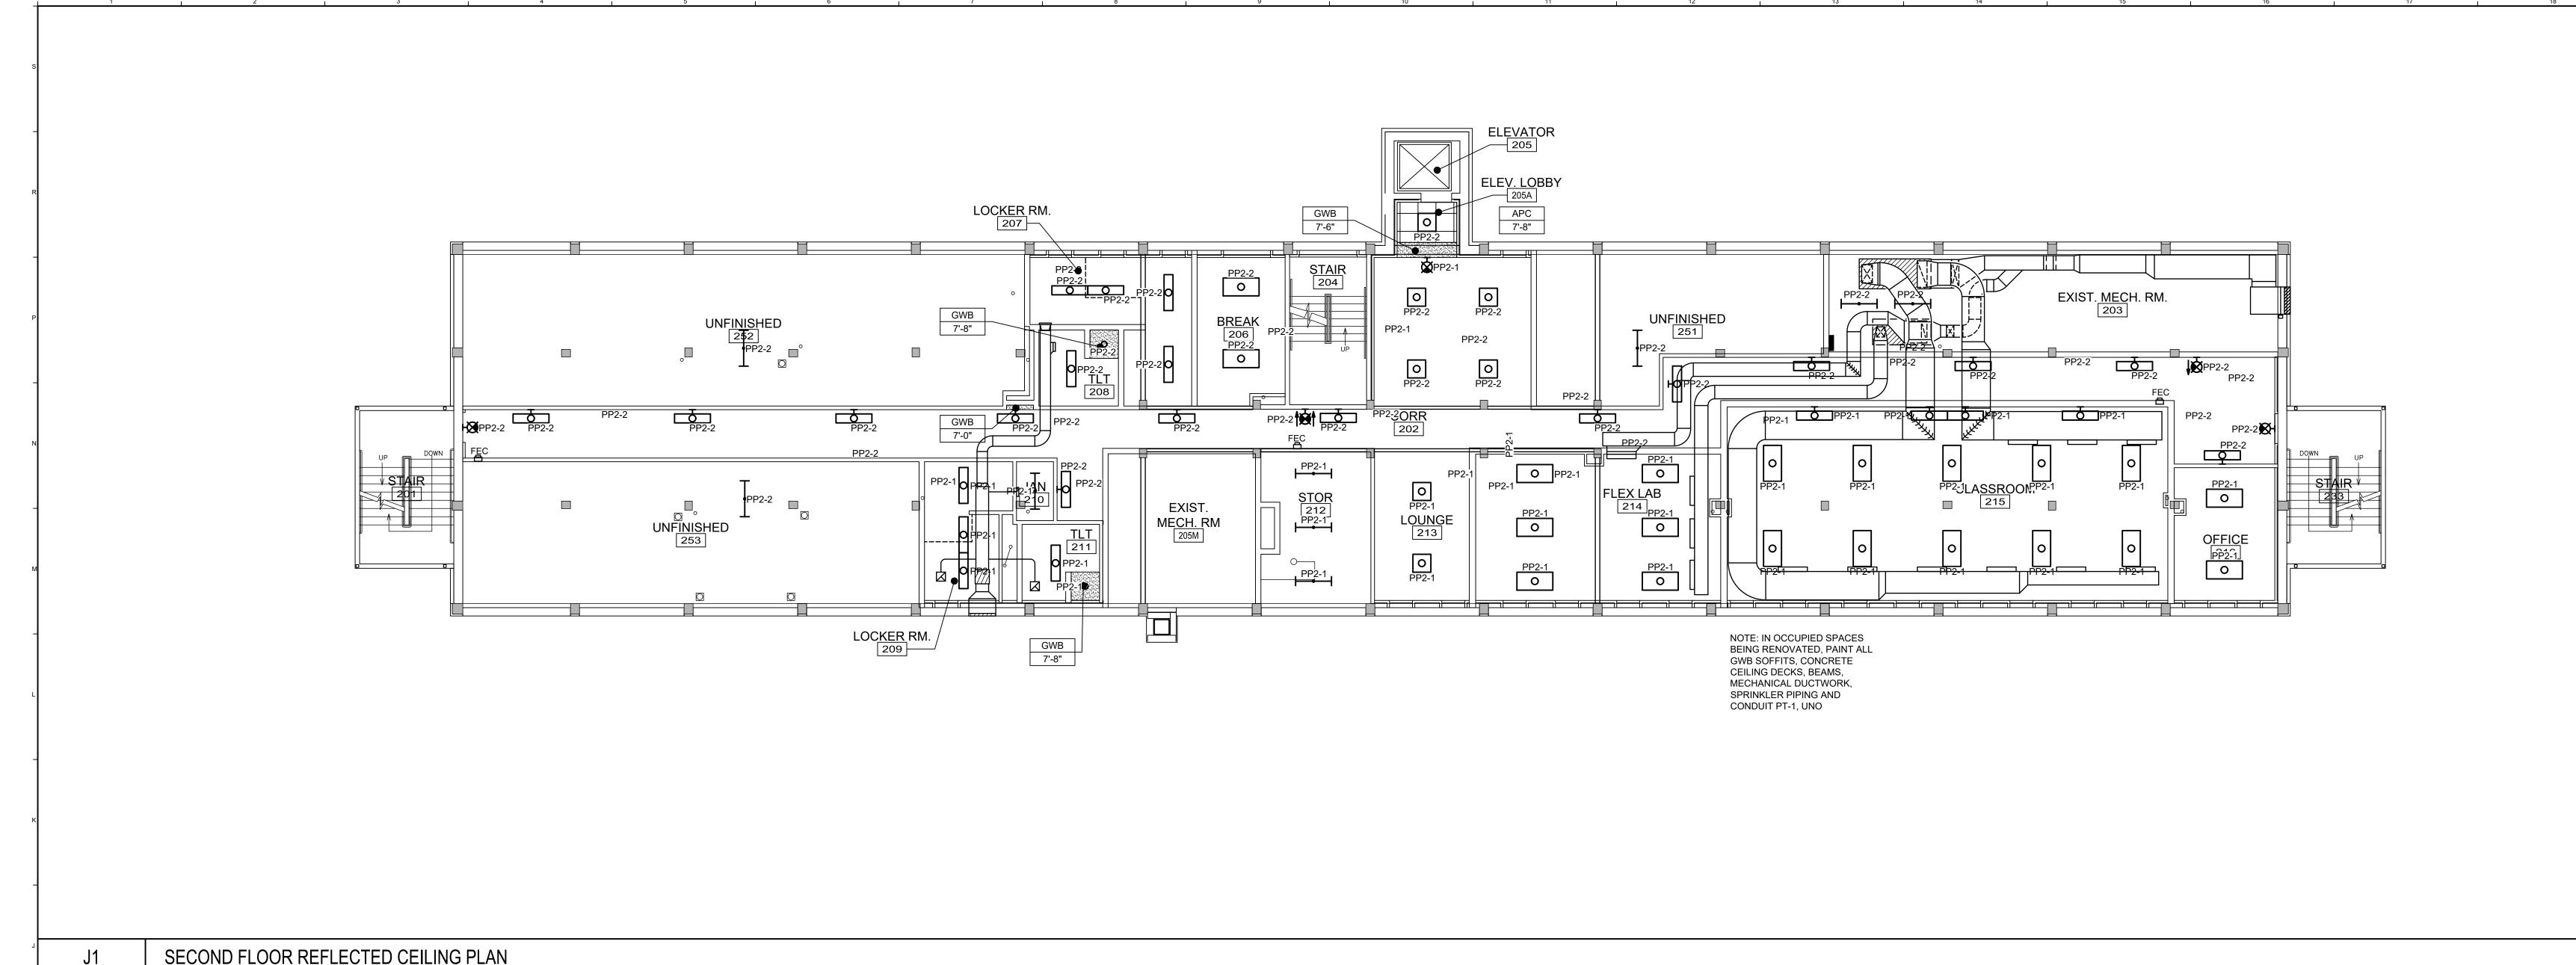

1/8" = 1'-0"

INCLUDE:

PT - PAINT SV - SHEET VINYL

WD - WOOD

INFORMATION.

AS FOLLOWS:

1/8" = 1'-0"

PT-1: CEILINGS AND UTILITIES

PT-2: HM FRAMES AND DOORS

PT-4 THRU 6: ACCENT WALLS

PT-3: TYPICAL WALLS

WAIN - WAINSCOT

CPT - CAPRET

CG - CORNER GUARD

ETR - EXISTING TO REMAIN


WB - RESILIENT WALL BASE

EWG - END WALL GUARD

PANELING LVT - LUXURY VINYL TILE PLAM - PLASTIC LAMINATE

CT - CERAMIC TILE

FINISH NOTES:

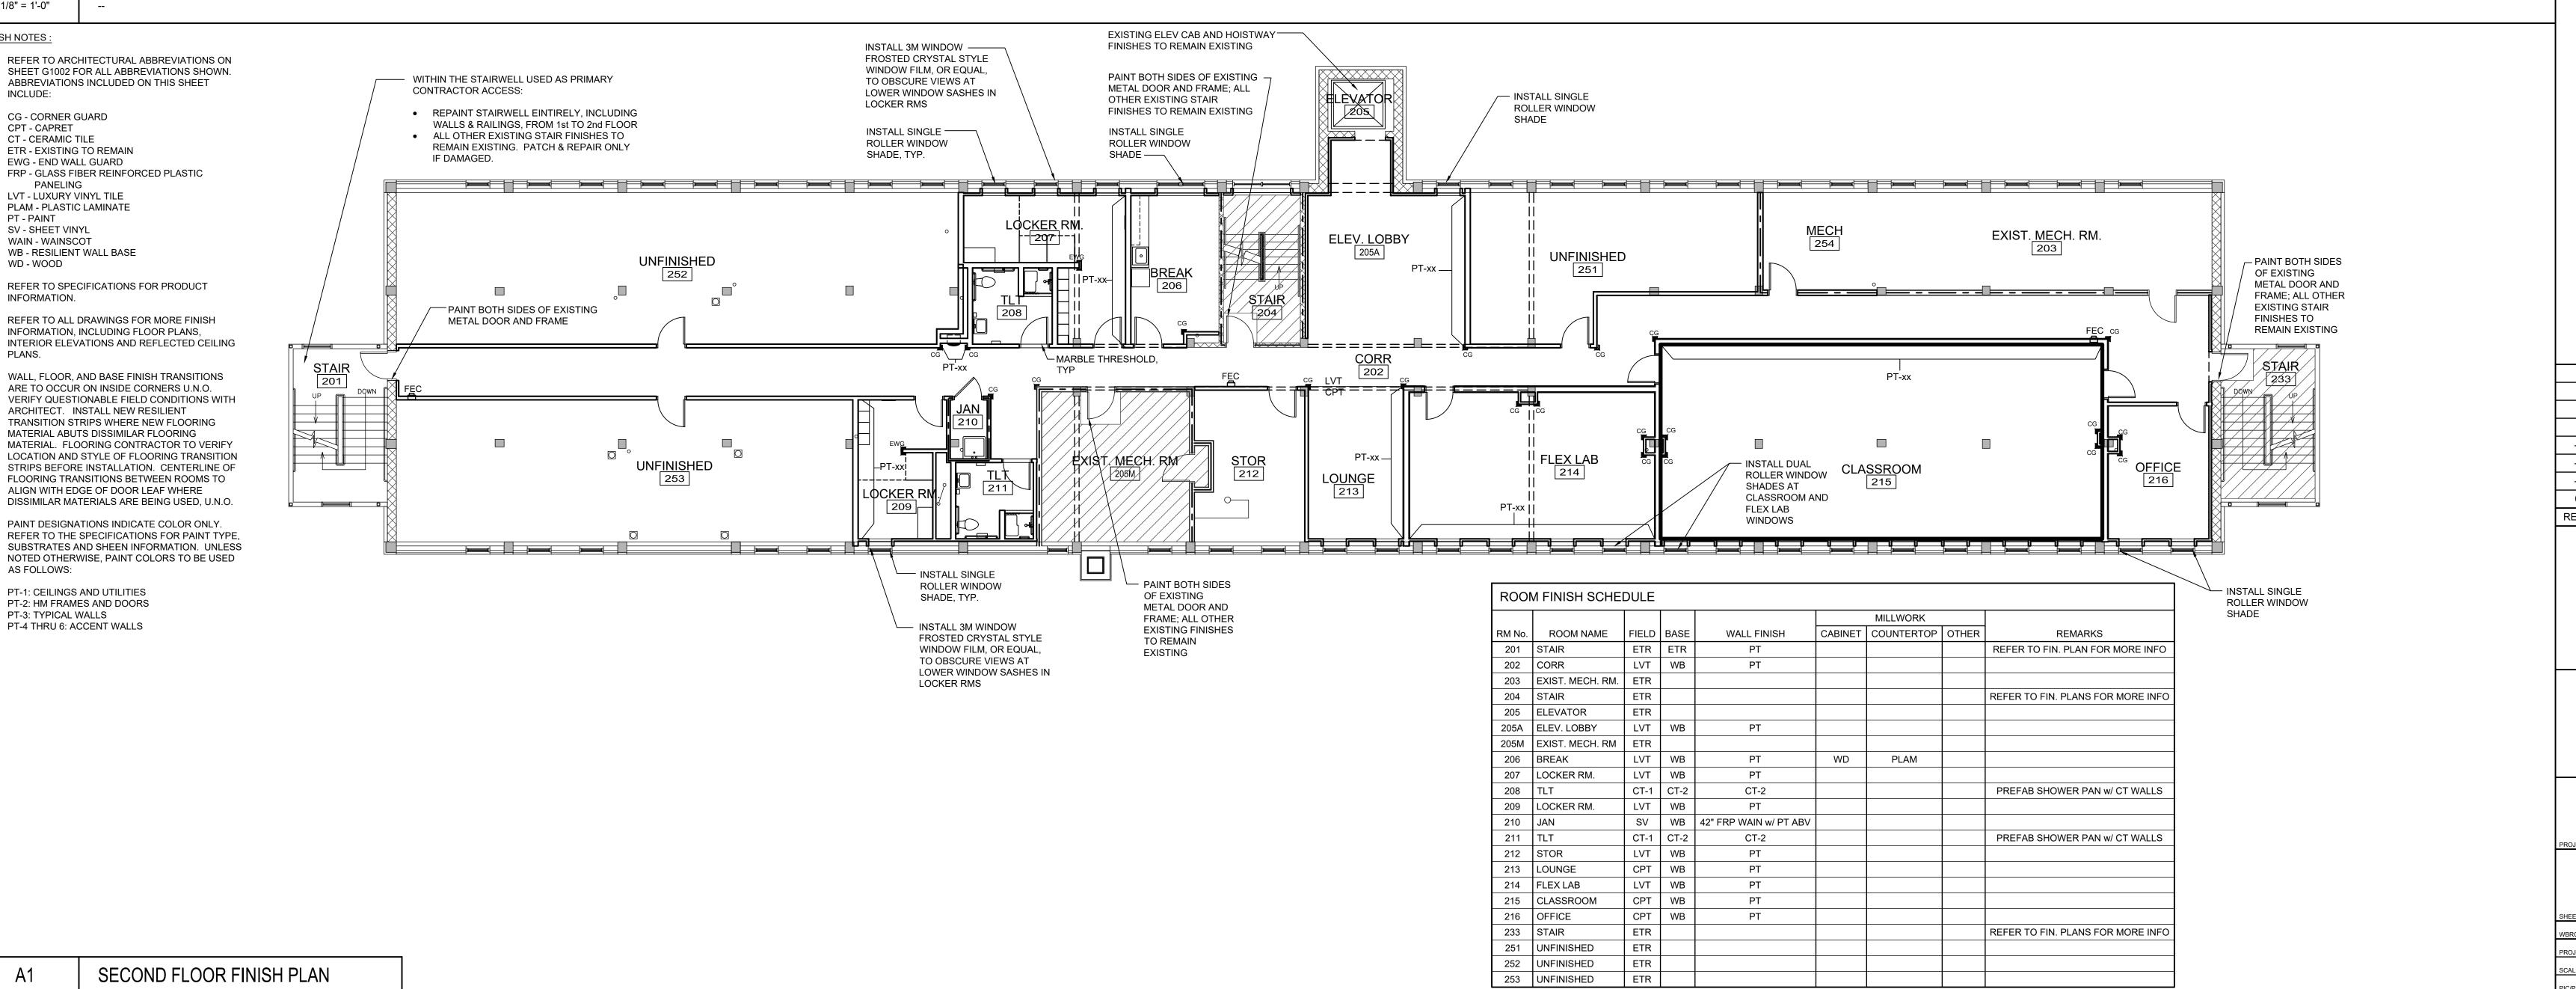

GENERAL CEILING PLAN NOTES

I. REFER TO SHEET GI002 FOR ALL ABBREVIATIONS. 2. ALL HEIGHTS GIVEN ARE FROM FINISHED FLOOR OF

BUILDING. 3. CONTRACTOR TO VERIFY LOCATION OF MAIN CEILING

TEE'S BEFORE PROCEEDING WITH FIXTURE INSTALLATION NOTIFY ARCHITECT OF INTERFERENCES.

4. NOTIFY ARCHITECT OF ANY DISCREPANCIES BETWEEN ARCHITECTURAL REFLECTED CEILING PLANS AND ELECTRICAL LIGHTING PLANS PRIOR TO CONSTRUCTION.

5. REFER TO ELECTRICAL PLANS FOR LOCATION OF STROBES AND EXIT SIGNS.

7. ALL SPRINKLER HEADS TO OCCUR AT CENTER OF

6. ALL CEILING GRILLES, TRIM EDGES, AND SLOT DIFFUSERS TO MATCH ADJACENT CEILING COLOR.

3. LAYOUT TILES AS SHOWN IN REFLECTED CEILING

PLAN. ALL CEILINGS TO BE A.F.F UNLESS NOTED OTHERWISE. SEE ELECTRICAL, MECHANICAL, AND PLUMBING SHEETS FOR ADDITIONAL INFORMATION.

9. ALL RECESSED LIGHT FIXTURES IN ACOUSTIC PANEL CEILING GRID TO BE CENTERED IN TILE UNLESS NOTED OTHERWISE

#### CEILING LEGEND.

ELECTRICAL SYMBOLS INDICATING LIGHTING LOCATIONS. REFER TO EL SHEETS FOR SIZE / TYPE OF LIGHTING FIXTURES.



MECHANICAL SYMBOLS INDICATING SUPPLY DIFFUSER OR EXHAUST/RETURN GRILLE
LOCATIONS. REFER TO MH SHEETS FOR SIZE / TYPE OF DIFFUSER / GRILLE.





2'-0"x2'-0" ACOUSTICAL TILE CEILING & METAL SUSPENSION GRID.



NEW 5/8" GYPSUM WALL BOARD CEILING OR SOFFIT.

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UMA BANGOR CAMDEN HALL SECOND FLOOR RENOVATION

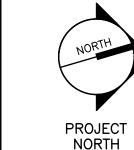BANGOR, ME SECOND FLOOR REFLECTED CEILING PLAN AND FINISH PLAN

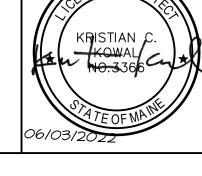
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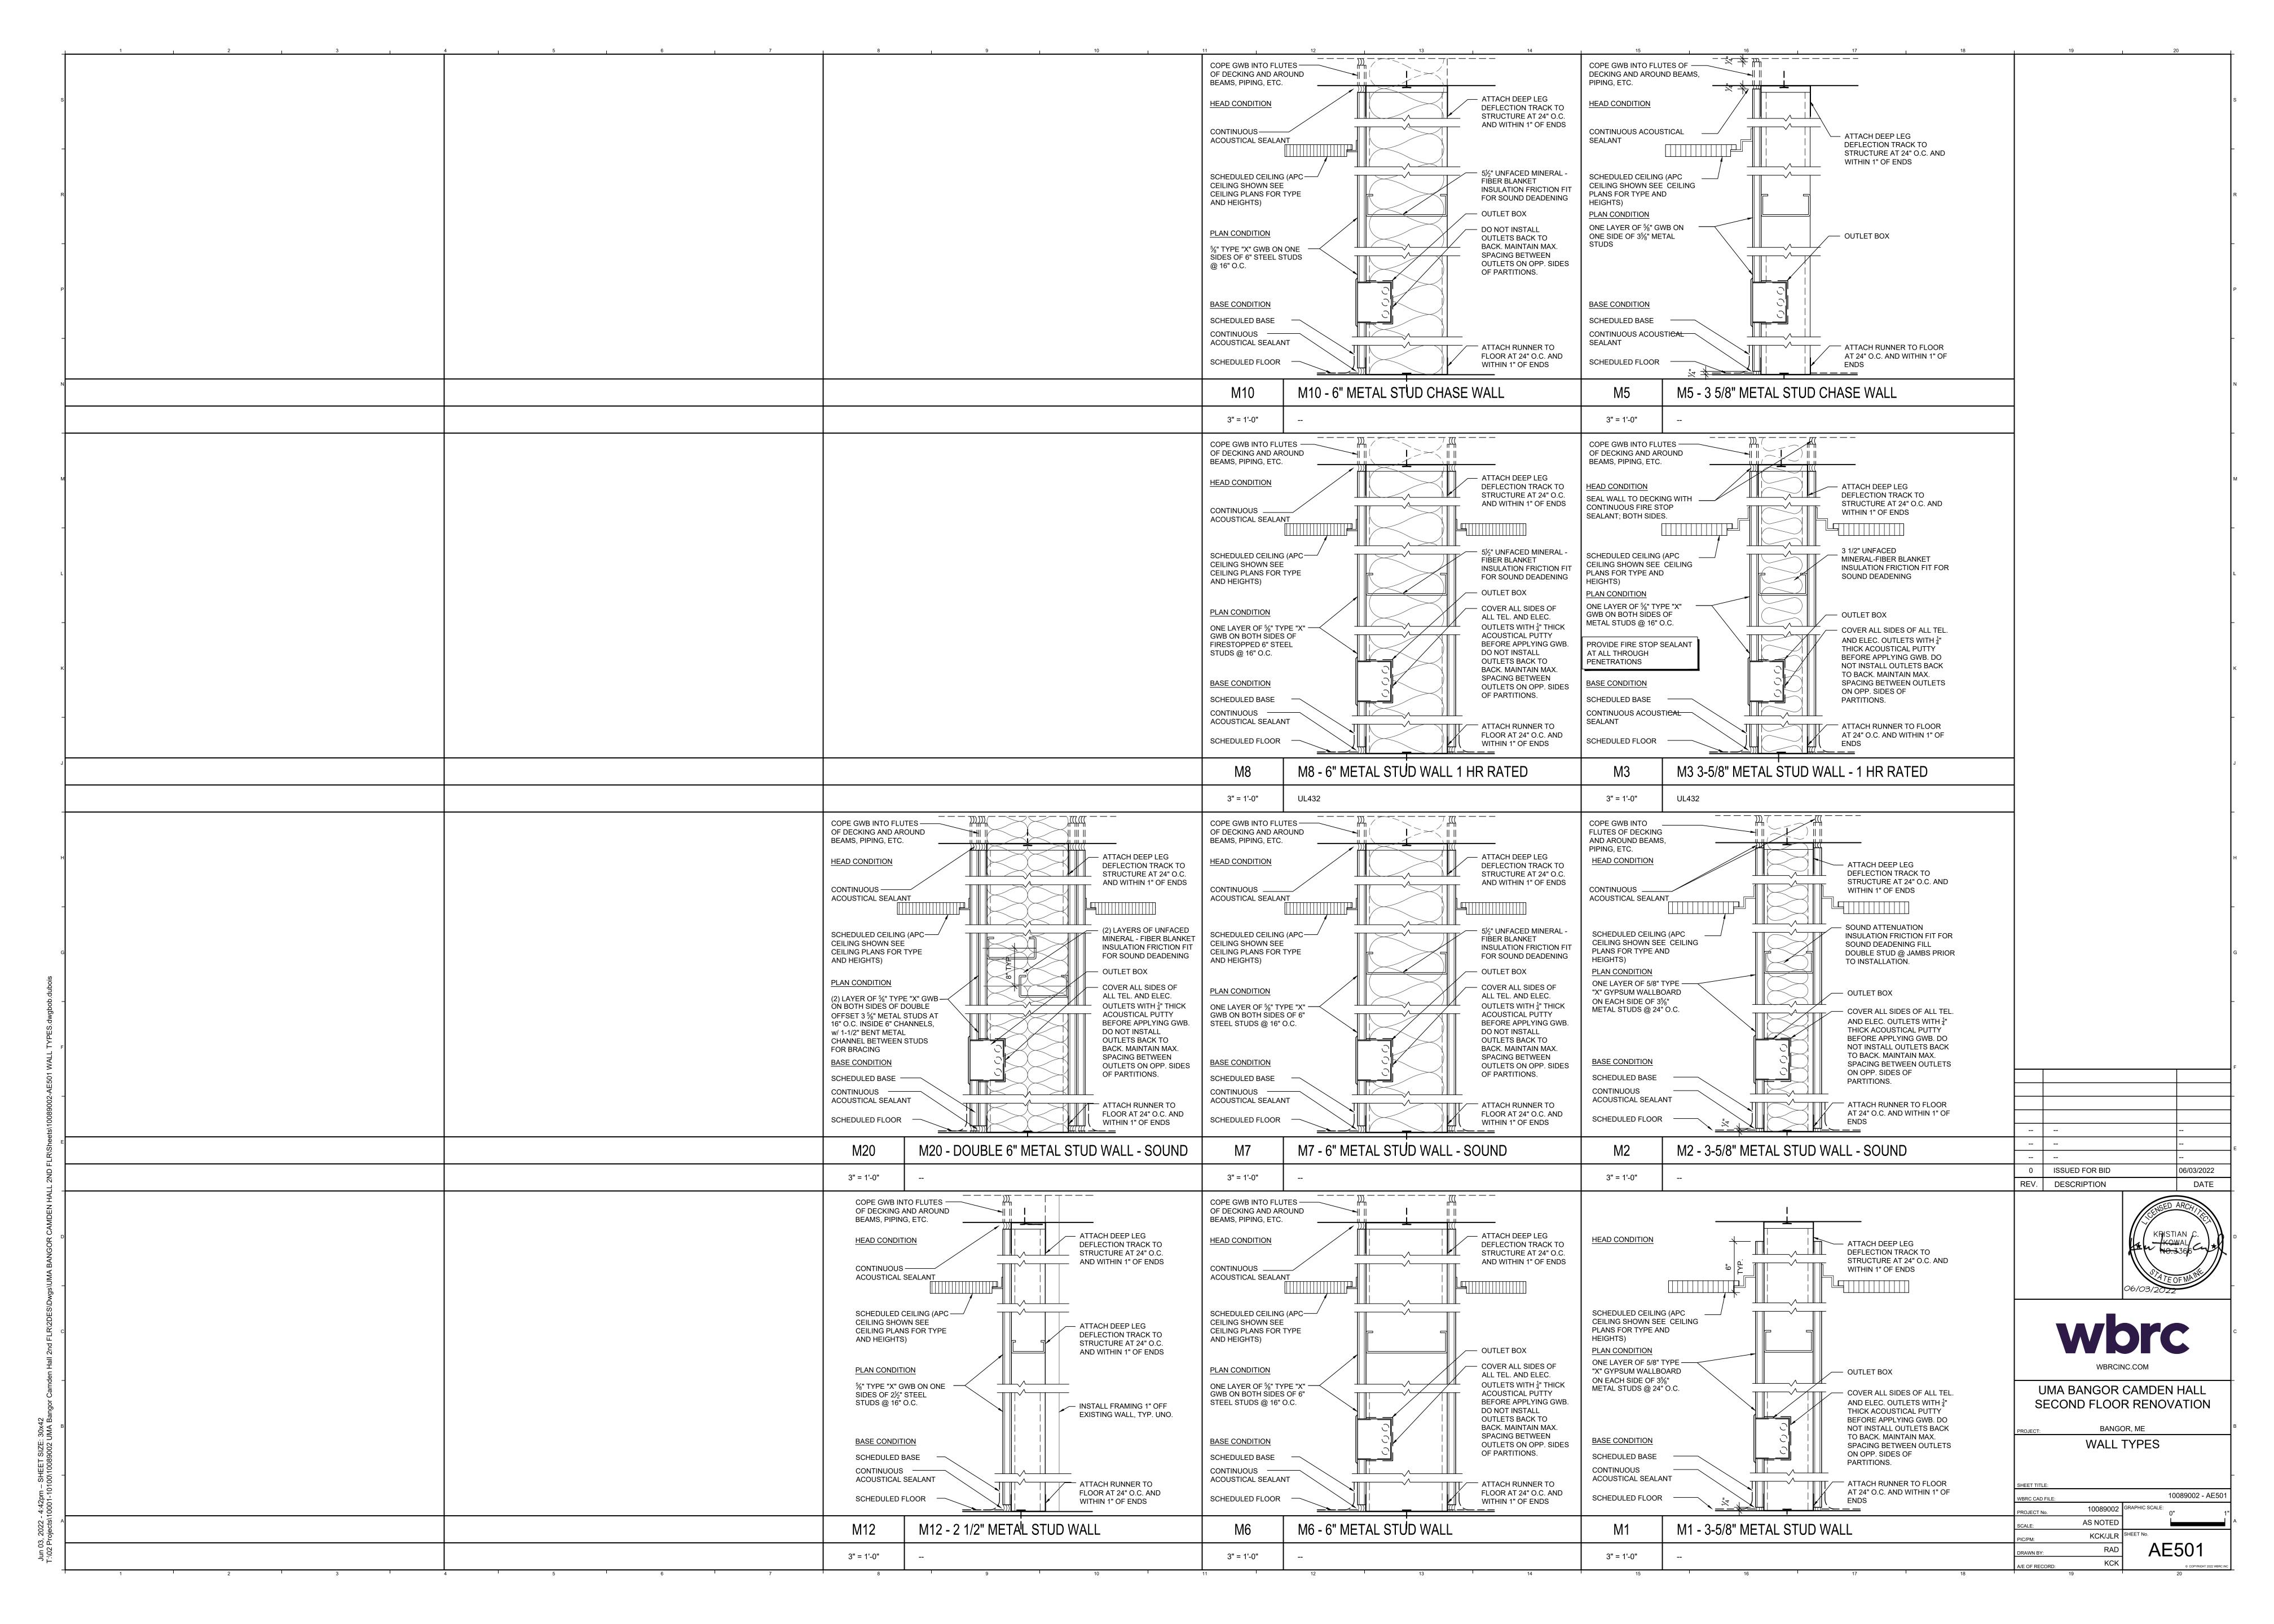
KCK


10089002 - AE105


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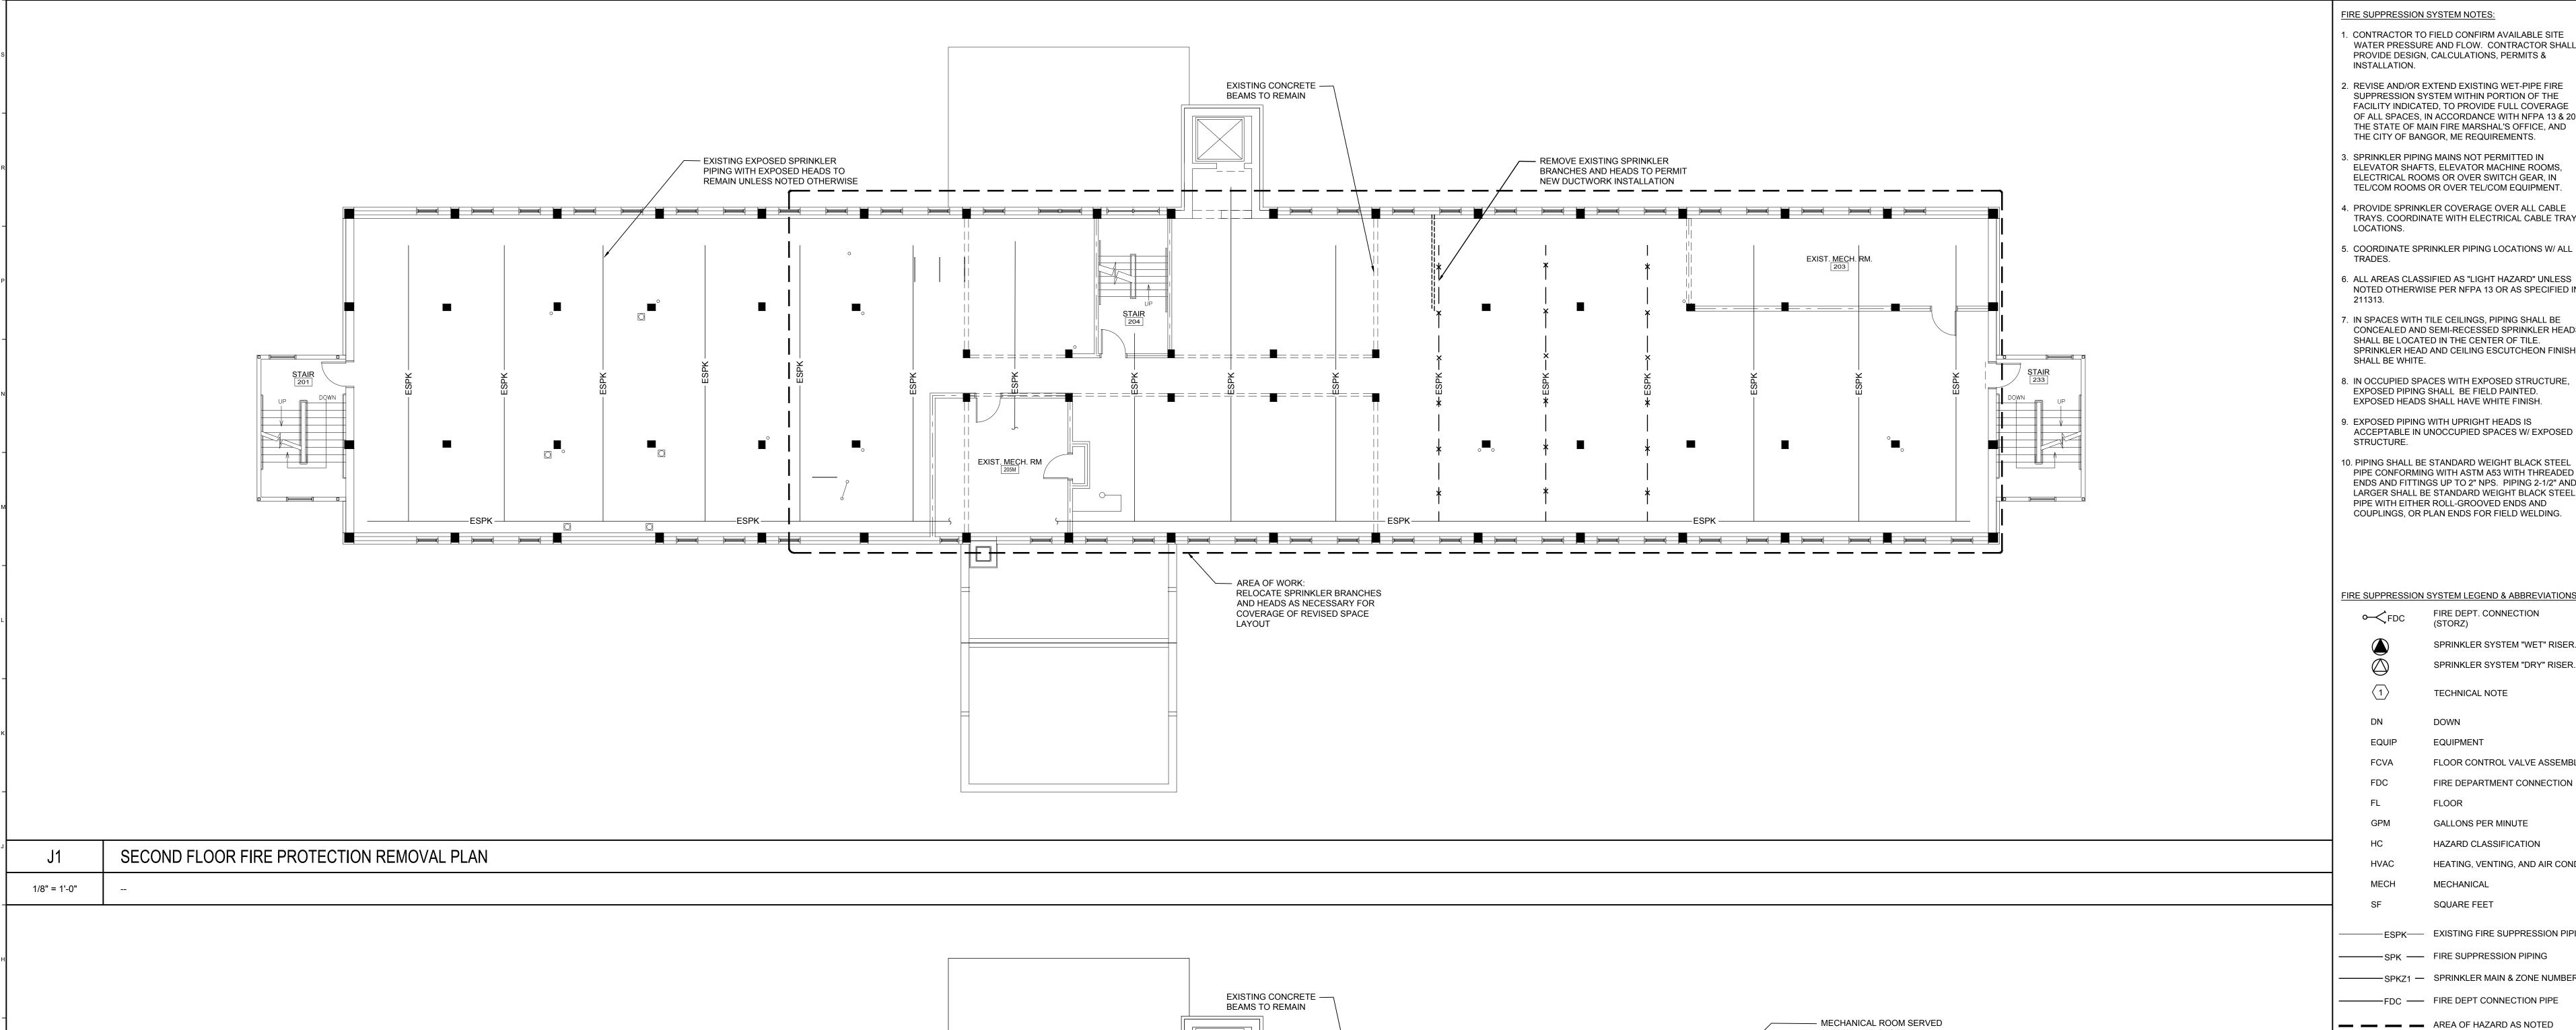
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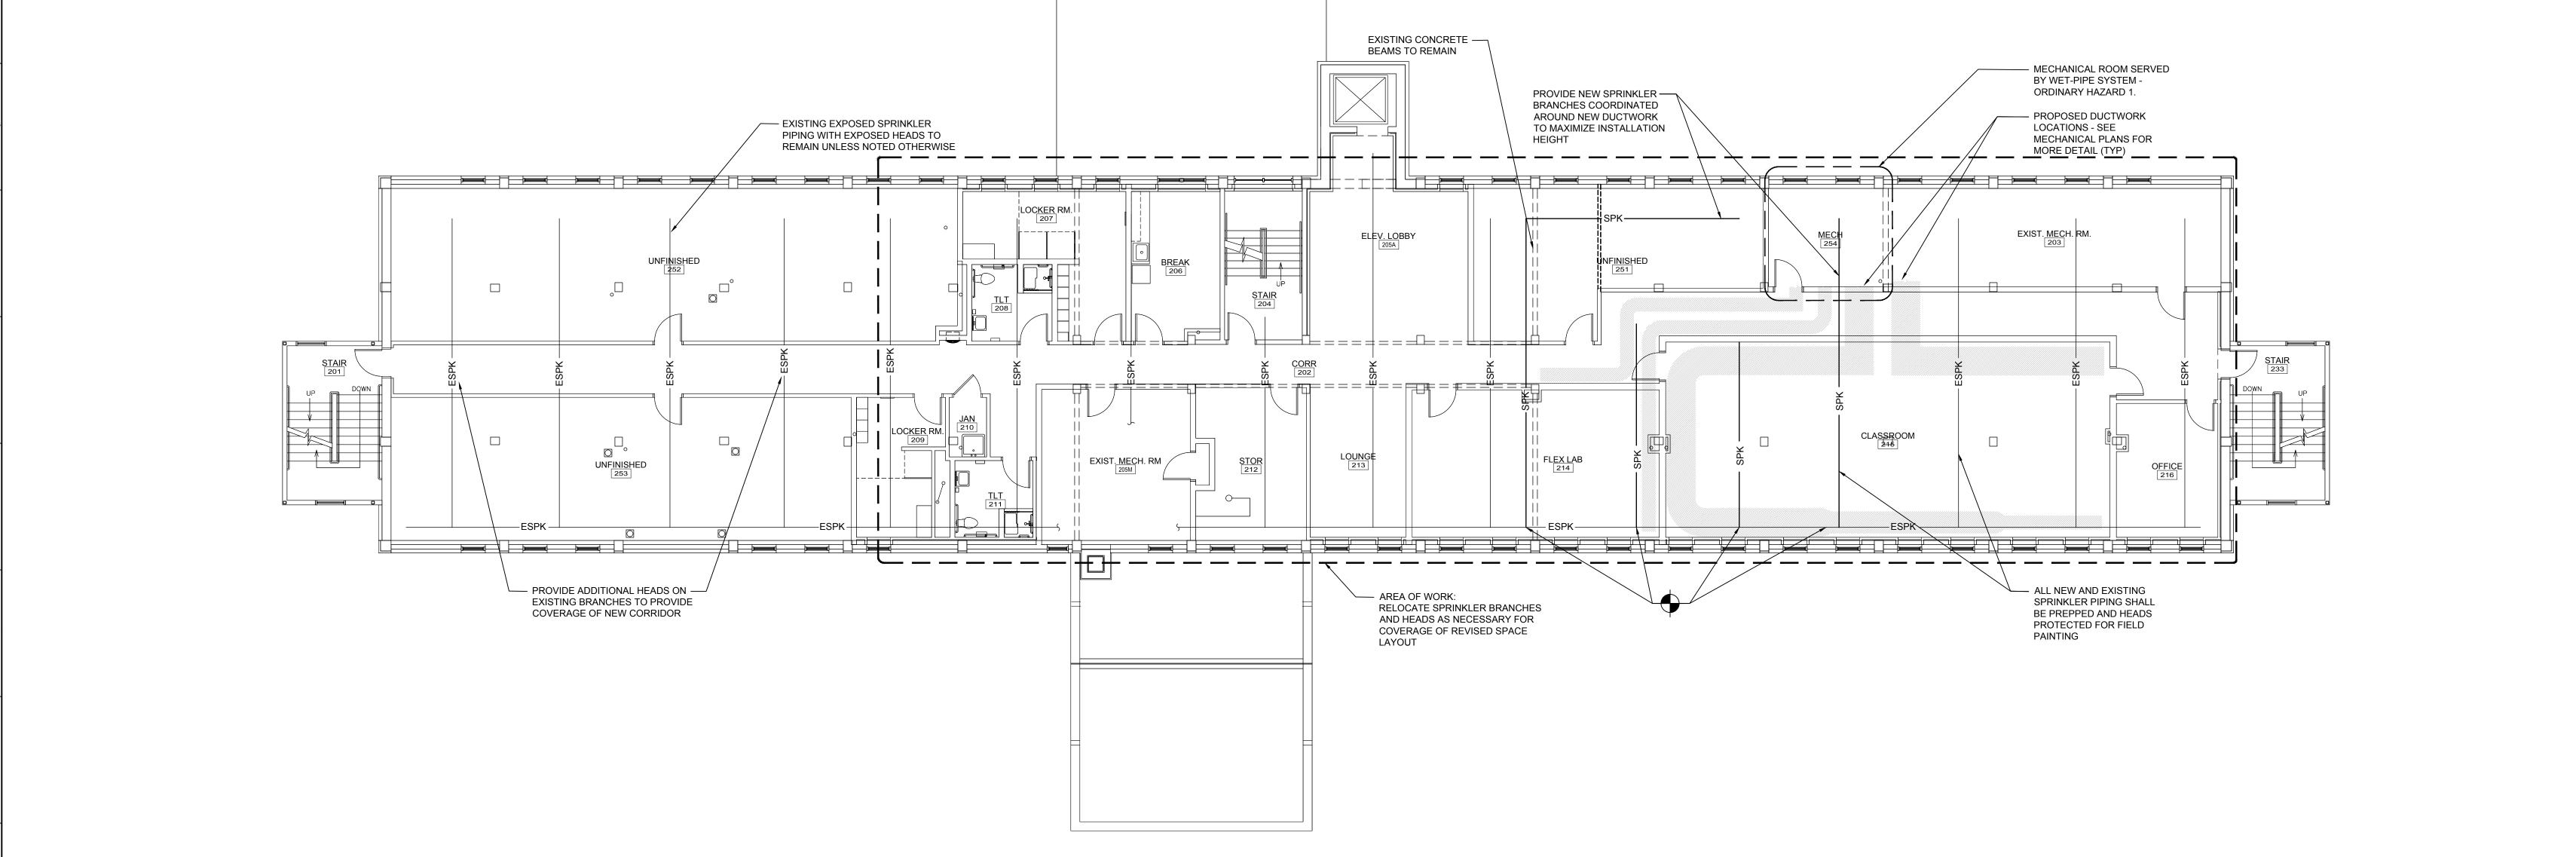






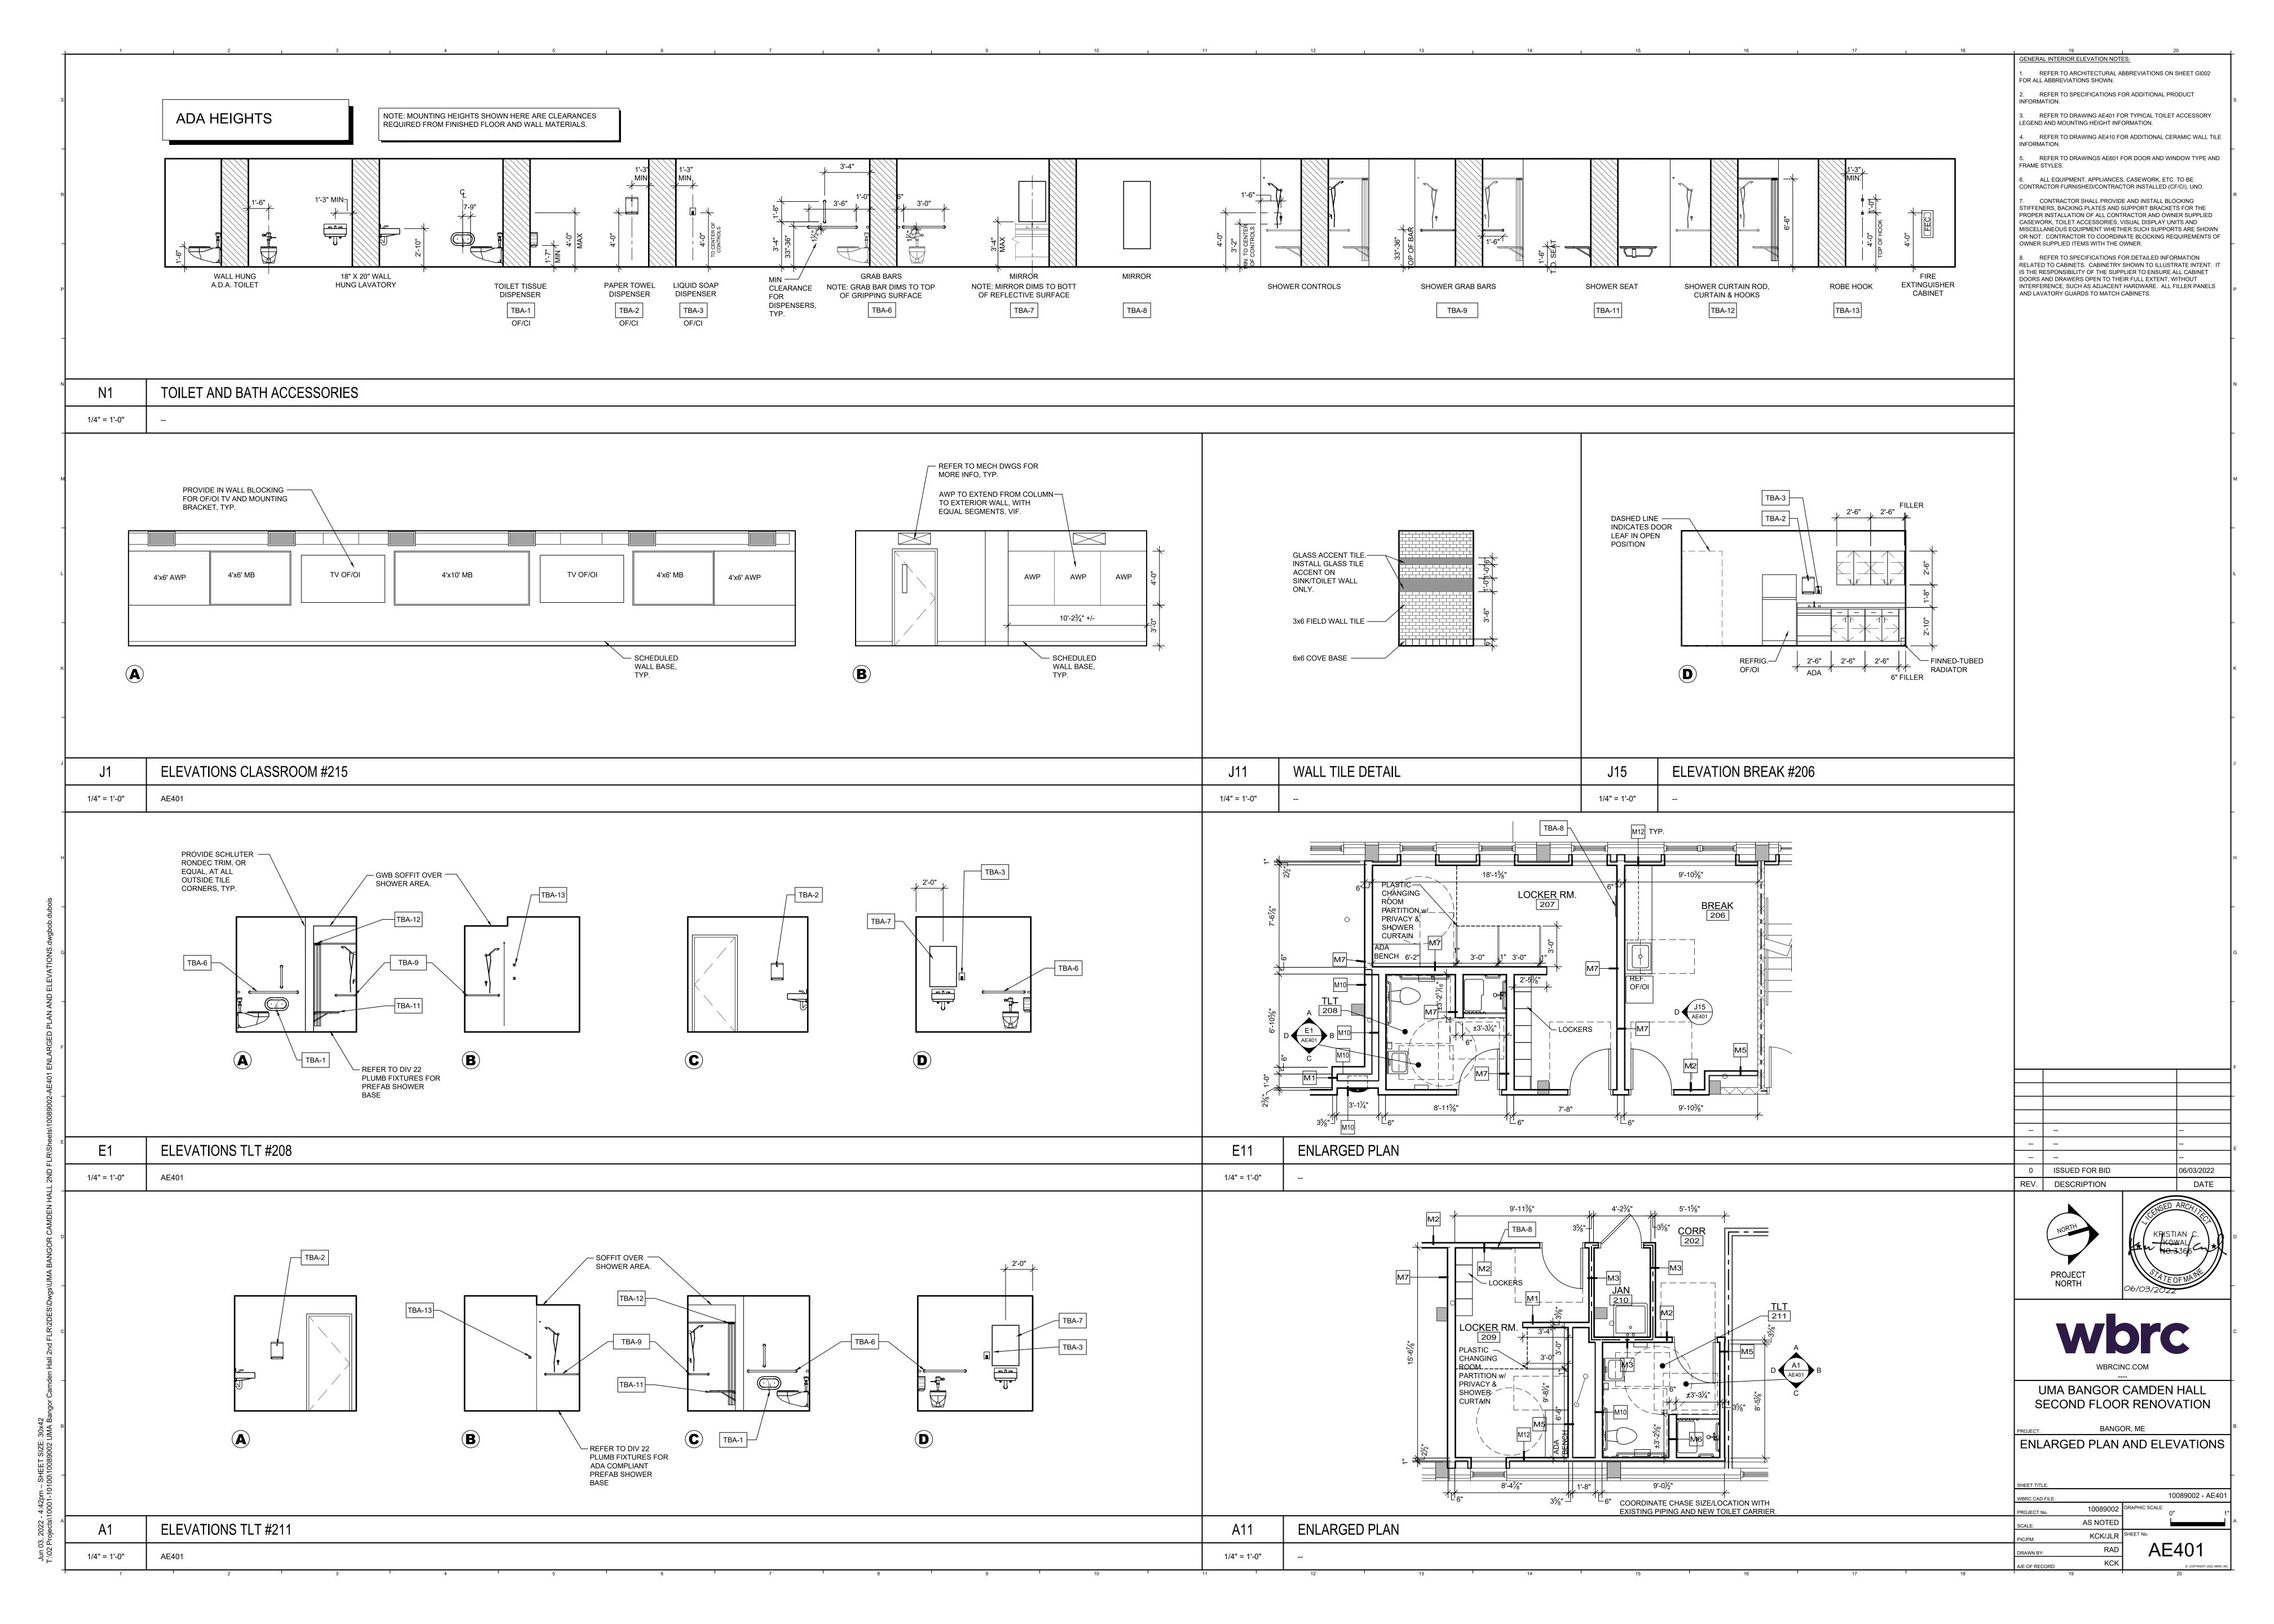

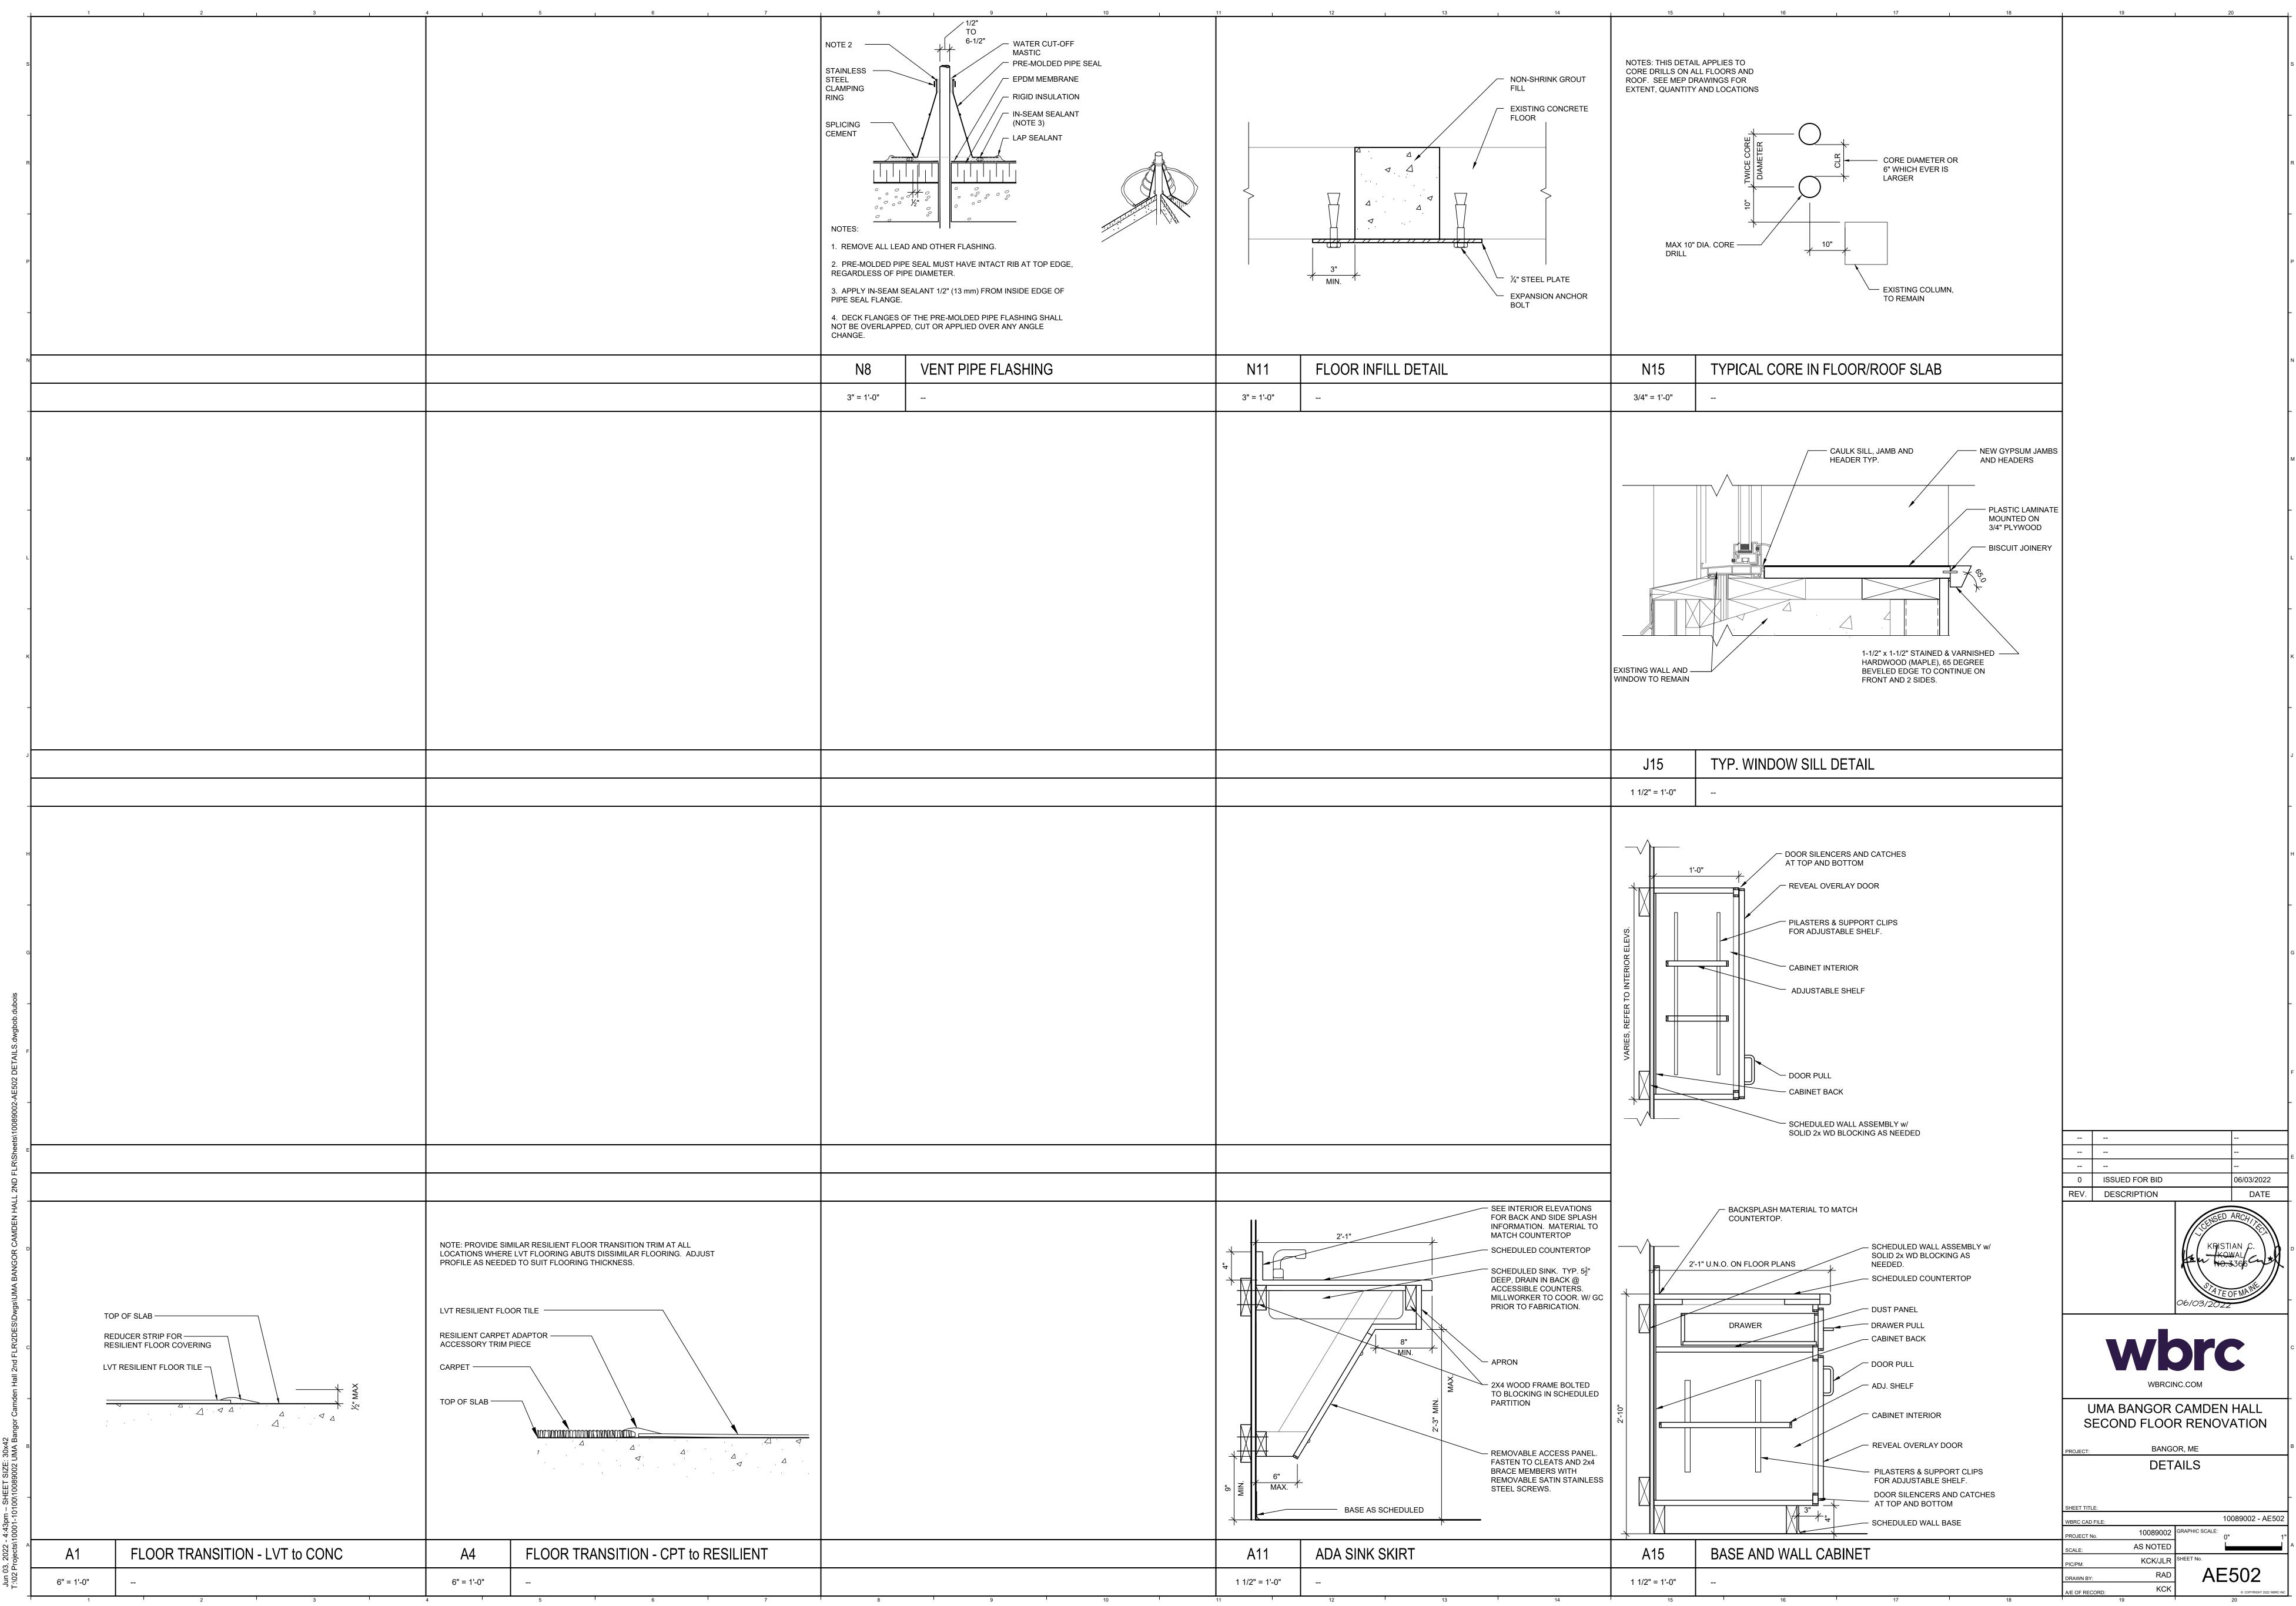

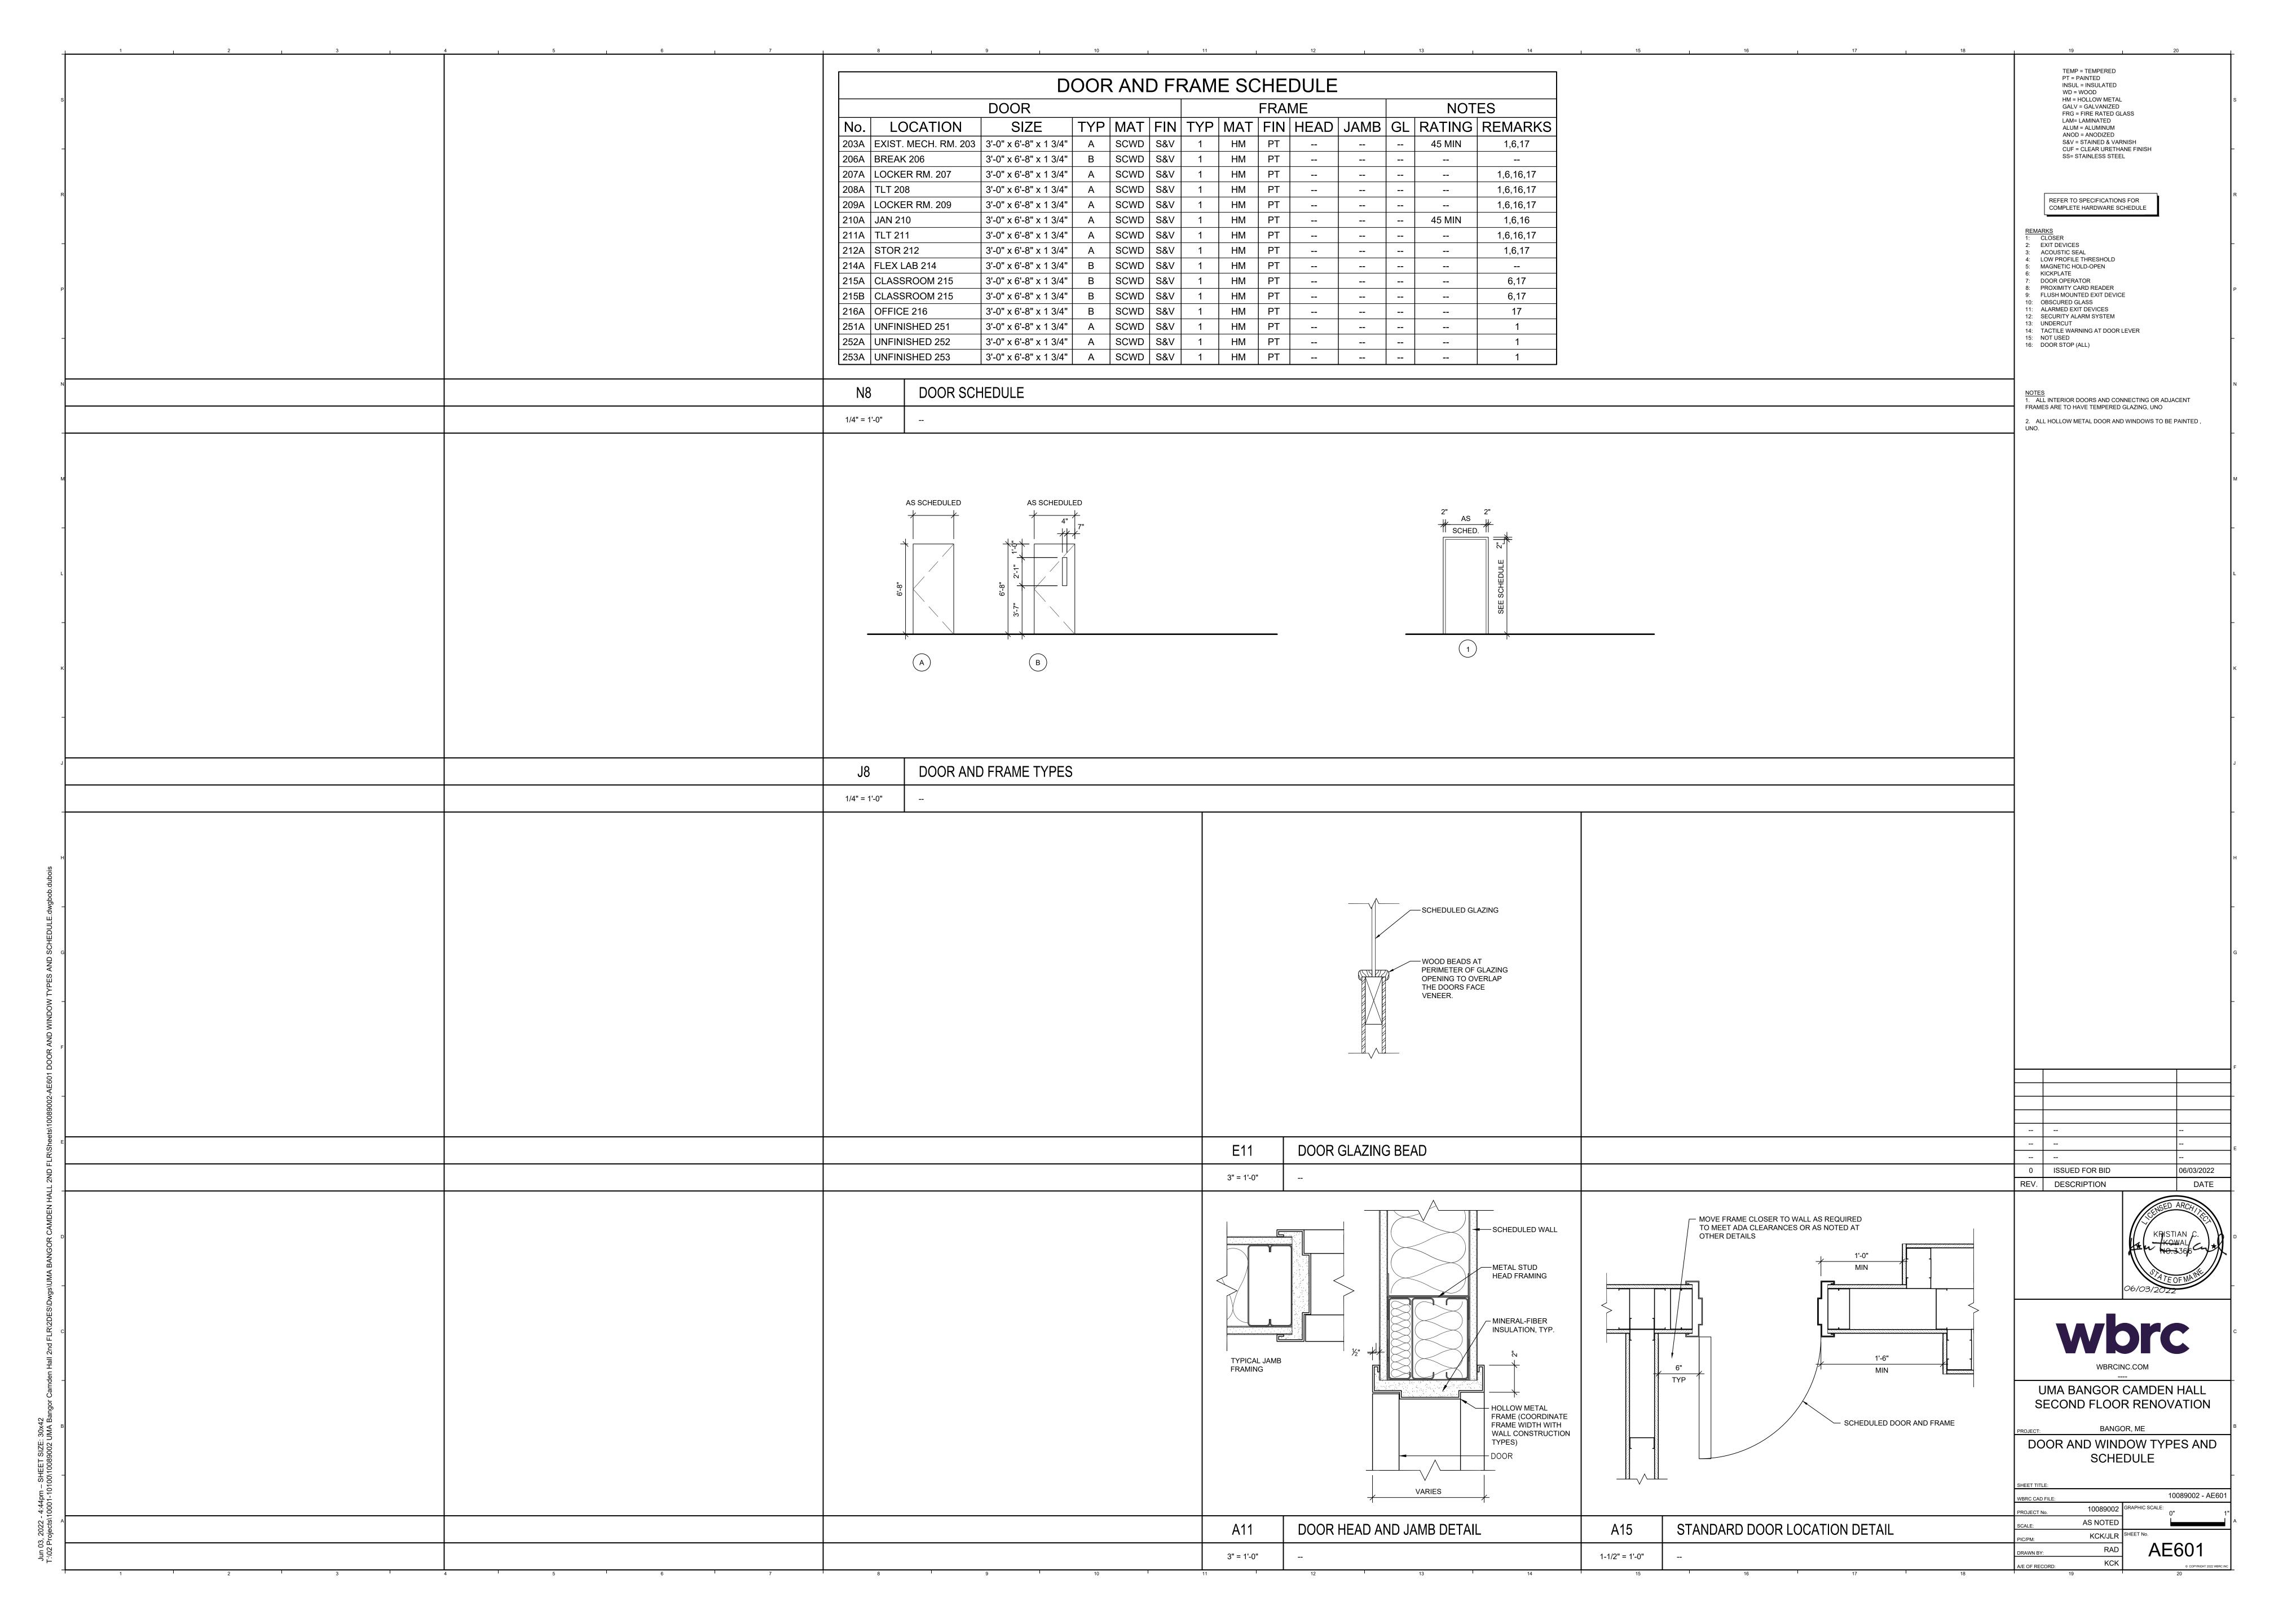

FIRE SUPPRESSION SYSTEM NOTES:

- 1. CONTRACTOR TO FIELD CONFIRM AVAILABLE SITE WATER PRESSURE AND FLOW. CONTRACTOR SHALL PROVIDE DESIGN, CALCULATIONS, PERMITS &
- 2. REVISE AND/OR EXTEND EXISTING WET-PIPE FIRE SUPPRESSION SYSTEM WITHIN PORTION OF THE FACILITY INDICATED, TO PROVIDE FULL COVERAGE OF ALL SPACES, IN ACCORDANCE WITH NFPA 13 & 20, THE STATE OF MAIN FIRE MARSHAL'S OFFICE, AND THE CITY OF BANGOR, ME REQUIREMENTS.
- 3. SPRINKLER PIPING MAINS NOT PERMITTED IN ELEVATOR SHAFTS, ELEVATOR MACHINE ROOMS, ELECTRICAL ROOMS OR OVER SWITCH GEAR, IN
- TEL/COM ROOMS OR OVER TEL/COM EQUIPMENT. 4. PROVIDE SPRINKLER COVERAGE OVER ALL CABLE
- TRAYS. COORDINATE WITH ELECTRICAL CABLE TRAY LOCATIONS.
- 6. ALL AREAS CLASSIFIED AS "LIGHT HAZARD" UNLESS
- NOTED OTHERWISE PER NFPA 13 OR AS SPECIFIED IN
- 7. IN SPACES WITH TILE CEILINGS, PIPING SHALL BE CONCEALED AND SEMI-RECESSED SPRINKLER HEADS SHALL BE LOCATED IN THE CENTER OF TILE. SPRINKLER HEAD AND CEILING ESCUTCHEON FINISH
- 8. IN OCCUPIED SPACES WITH EXPOSED STRUCTURE, EXPOSED PIPING SHALL BE FIELD PAINTED. EXPOSED HEADS SHALL HAVE WHITE FINISH.
- 9. EXPOSED PIPING WITH UPRIGHT HEADS IS ACCEPTABLE IN UNOCCUPIED SPACES W/ EXPOSED
- 10. PIPING SHALL BE STANDARD WEIGHT BLACK STEEL PIPE CONFORMING WITH ASTM A53 WITH THREADED ENDS AND FITTINGS UP TO 2" NPS. PIPING 2-1/2" AND LARGER SHALL BE STANDARD WEIGHT BLACK STEEL PIPE WITH EITHER ROLL-GROOVED ENDS AND COUPLINGS, OR PLAN ENDS FOR FIELD WELDING.

#### FIRE SUPPRESSION SYSTEM LEGEND & ABBREVIATIONS

FIRE DEPT. CONNECTION

SPRINKLER SYSTEM "DRY" RISER.

SPRINKLER SYSTEM "WET" RISER.

TECHNICAL NOTE

**EQUIPMENT** 

FLOOR CONTROL VALVE ASSEMBLY

FIRE DEPARTMENT CONNECTION FLOOR

GALLONS PER MINUTE

HAZARD CLASSIFICATION

HEATING, VENTING, AND AIR COND.

MECHANICAL SQUARE FEET

—ESPK—— EXISTING FIRE SUPPRESSION PIPING

SPKZ1 — SPRINKLER MAIN & ZONE NUMBER FDC — FIRE DEPT CONNECTION PIPE

AREA OF HAZARD AS NOTED

0 ISSUED FOR BID

REV. DESCRIPTION



DATE

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UMA BANGOR CAMDEN HALL SECOND FLOOR RENOVATION


BANGOR, ME SECOND FLOOR FIRE PROTECTION

PLAN


10089002 - FX102 AS NOTED KCK/JLR SHEET No.


FX102

SECOND FLOOR FIRE PROTECTION PLAN 1/8" = 1'-0"

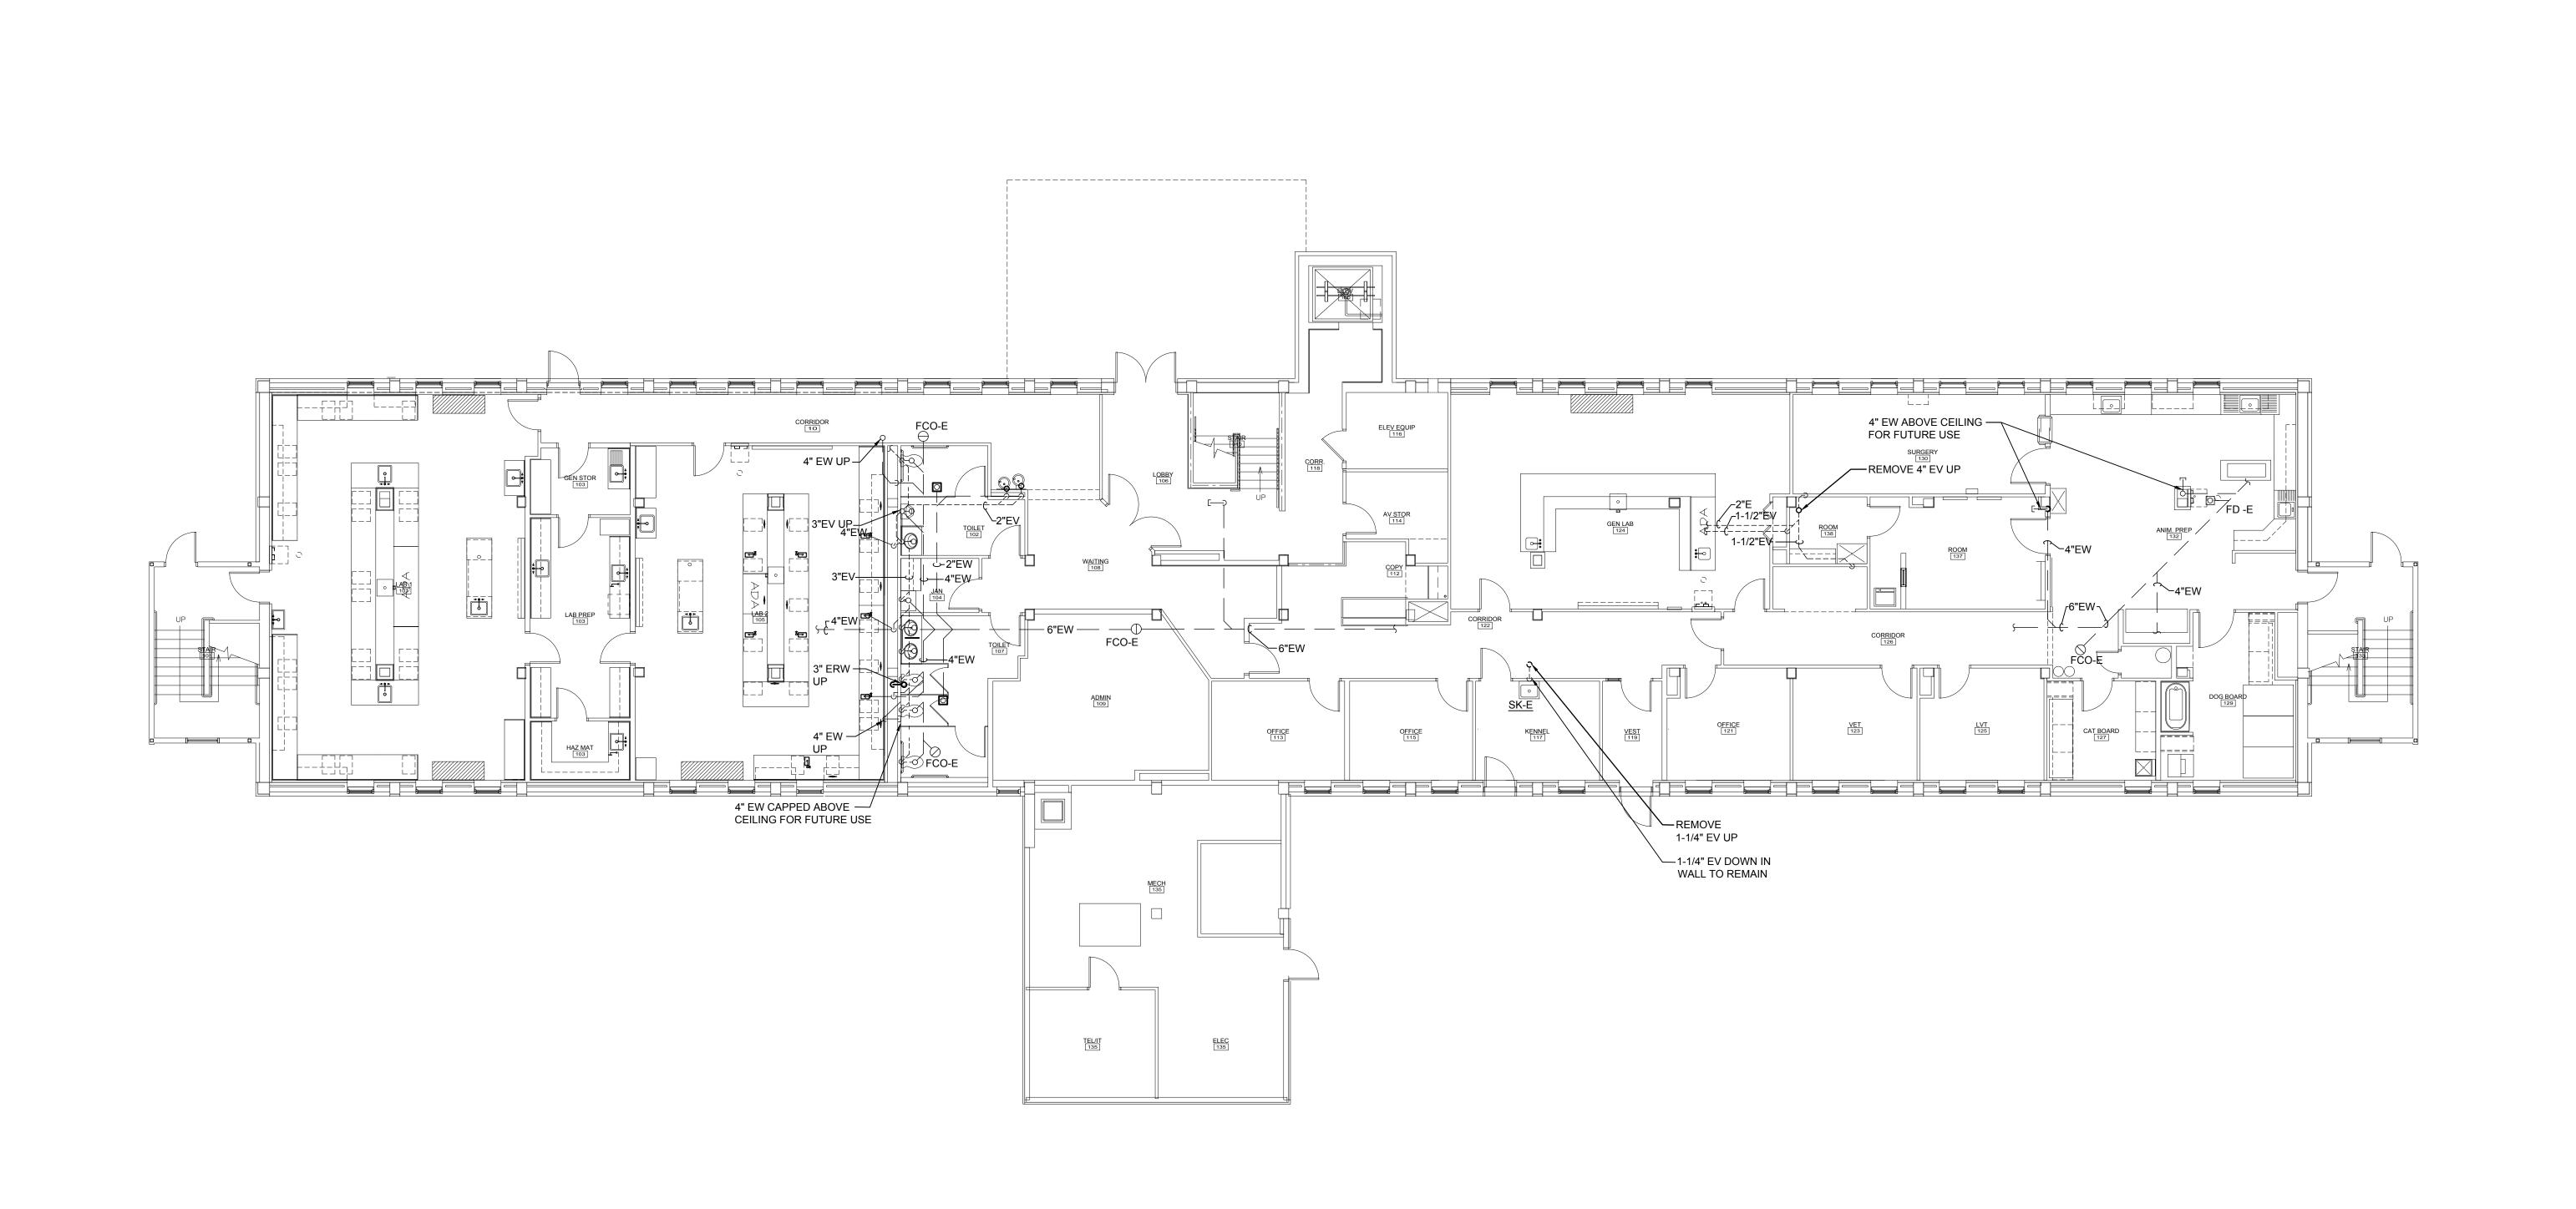

0 ISSUED FOR BID REV. DESCRIPTION

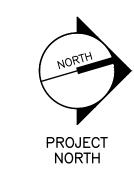

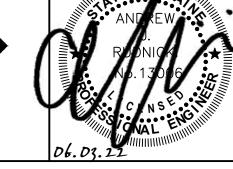

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UMA BANGOR CAMDEN HALL SECOND FLOOR RENOVATION

BANGOR, ME FIRST FLOOR PLUMBING REMOVAL PLAN


10089002 - PD101 AS NOTED

PD101

FIRST FLOOR PLUMBING REMOVAL PLAN


1/8" = 1'-0"

KCK/JLR SHEET NO.
SRJ
AJR

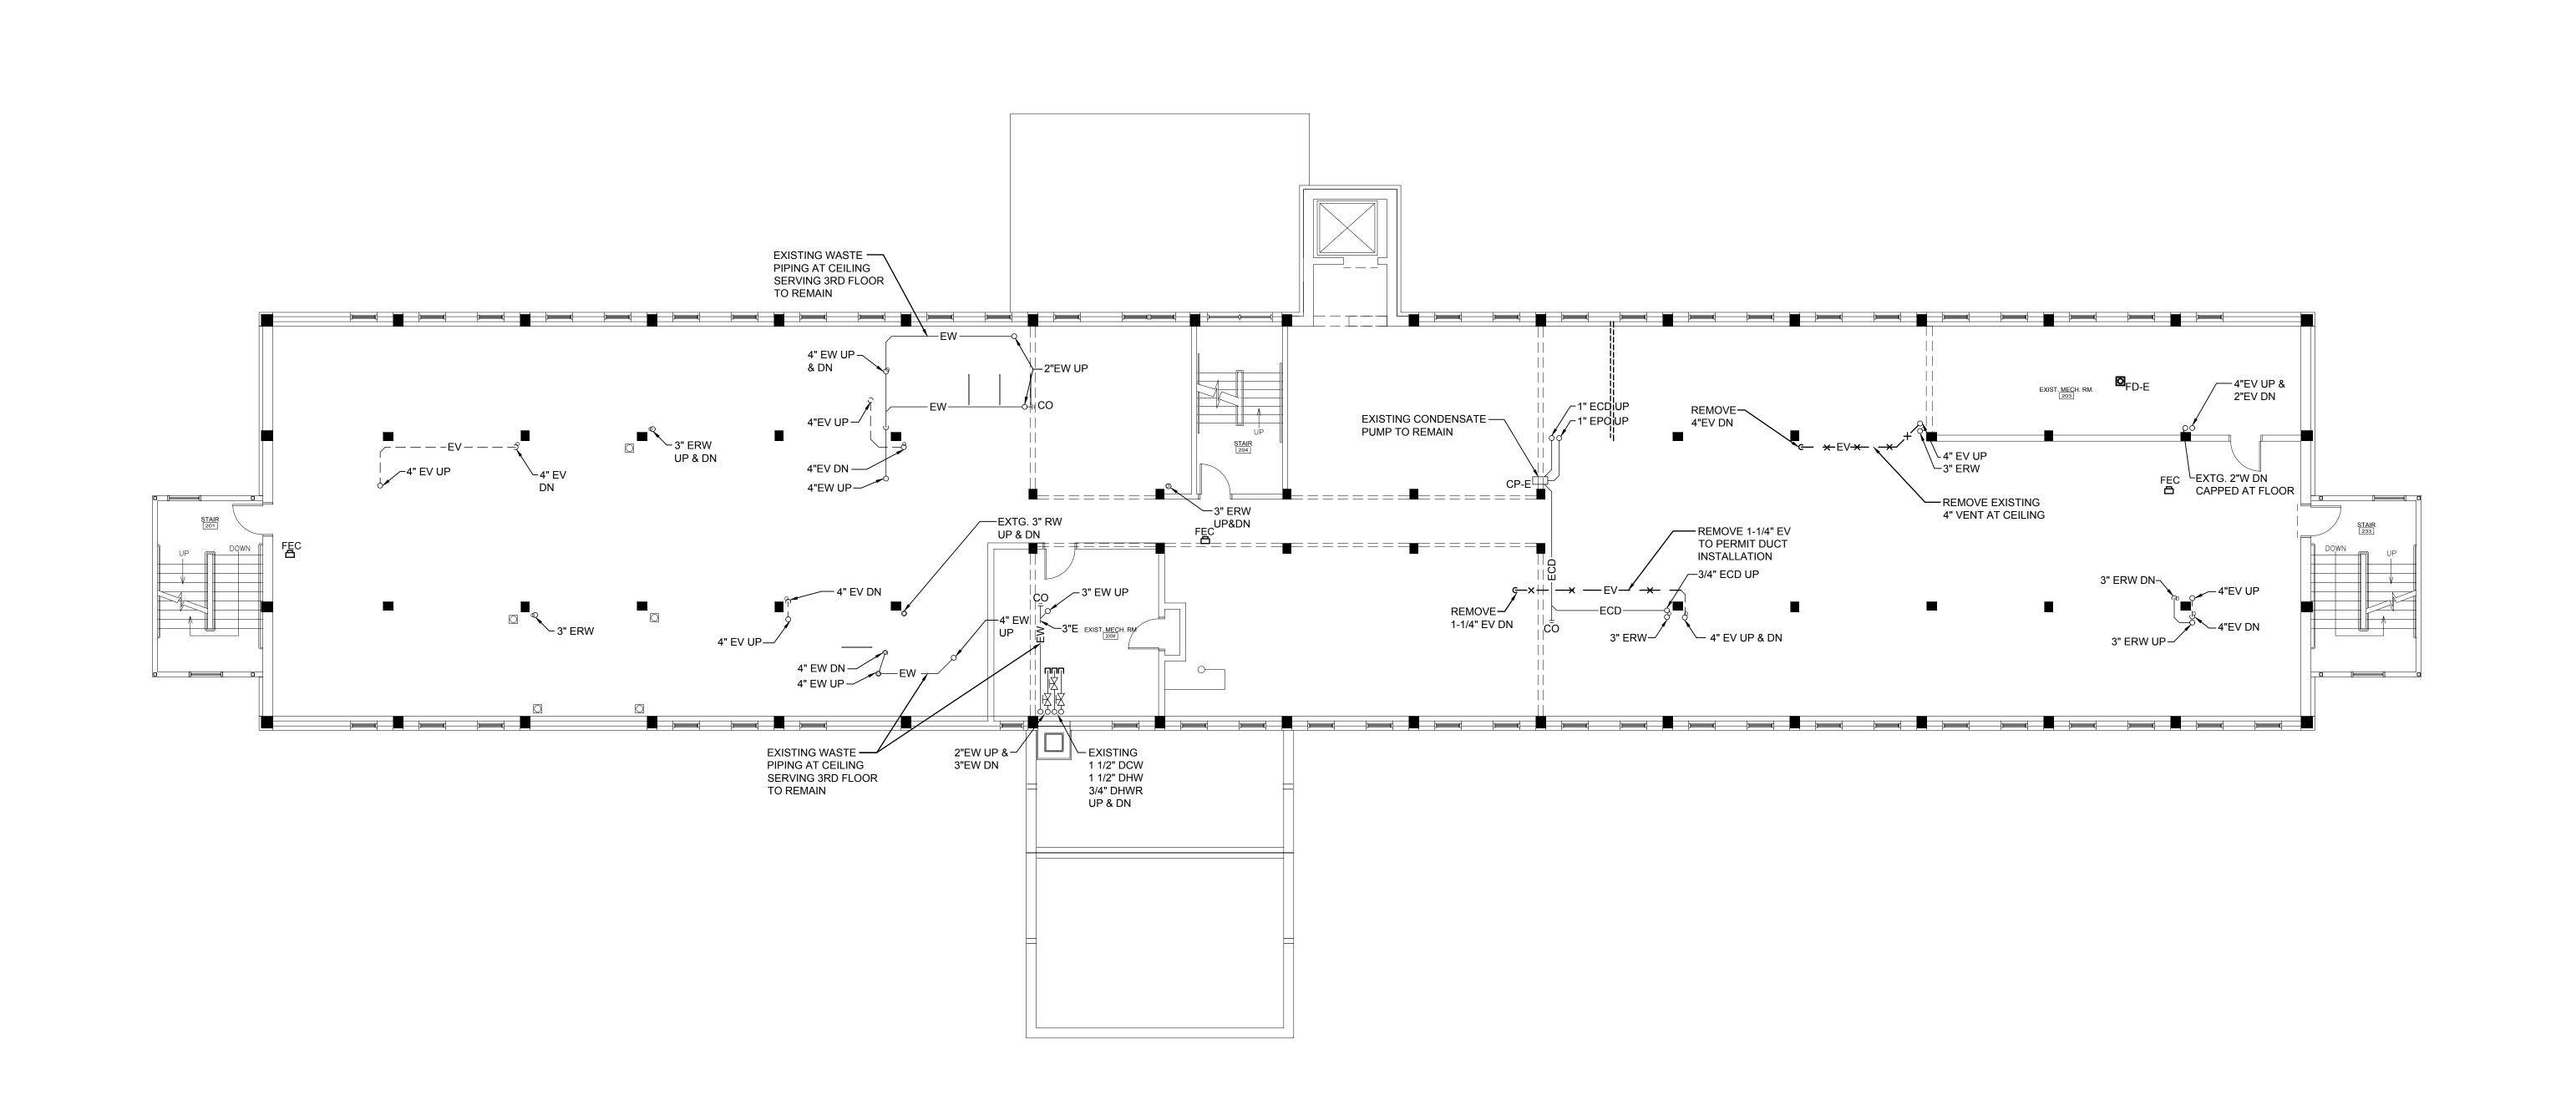

0 ISSUED FOR BID REV. DESCRIPTION



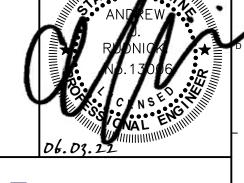

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UMA BANGOR CAMDEN HALL SECOND FLOOR RENOVATION

BANGOR, ME SECOND FLOOR PLUMBING REMOVAL PLAN


AS NOTED KCK/JLR SHEET No.

PD102

10089002 - PD102

SECOND FLOOR PLUMBING REMOVAL PLAN


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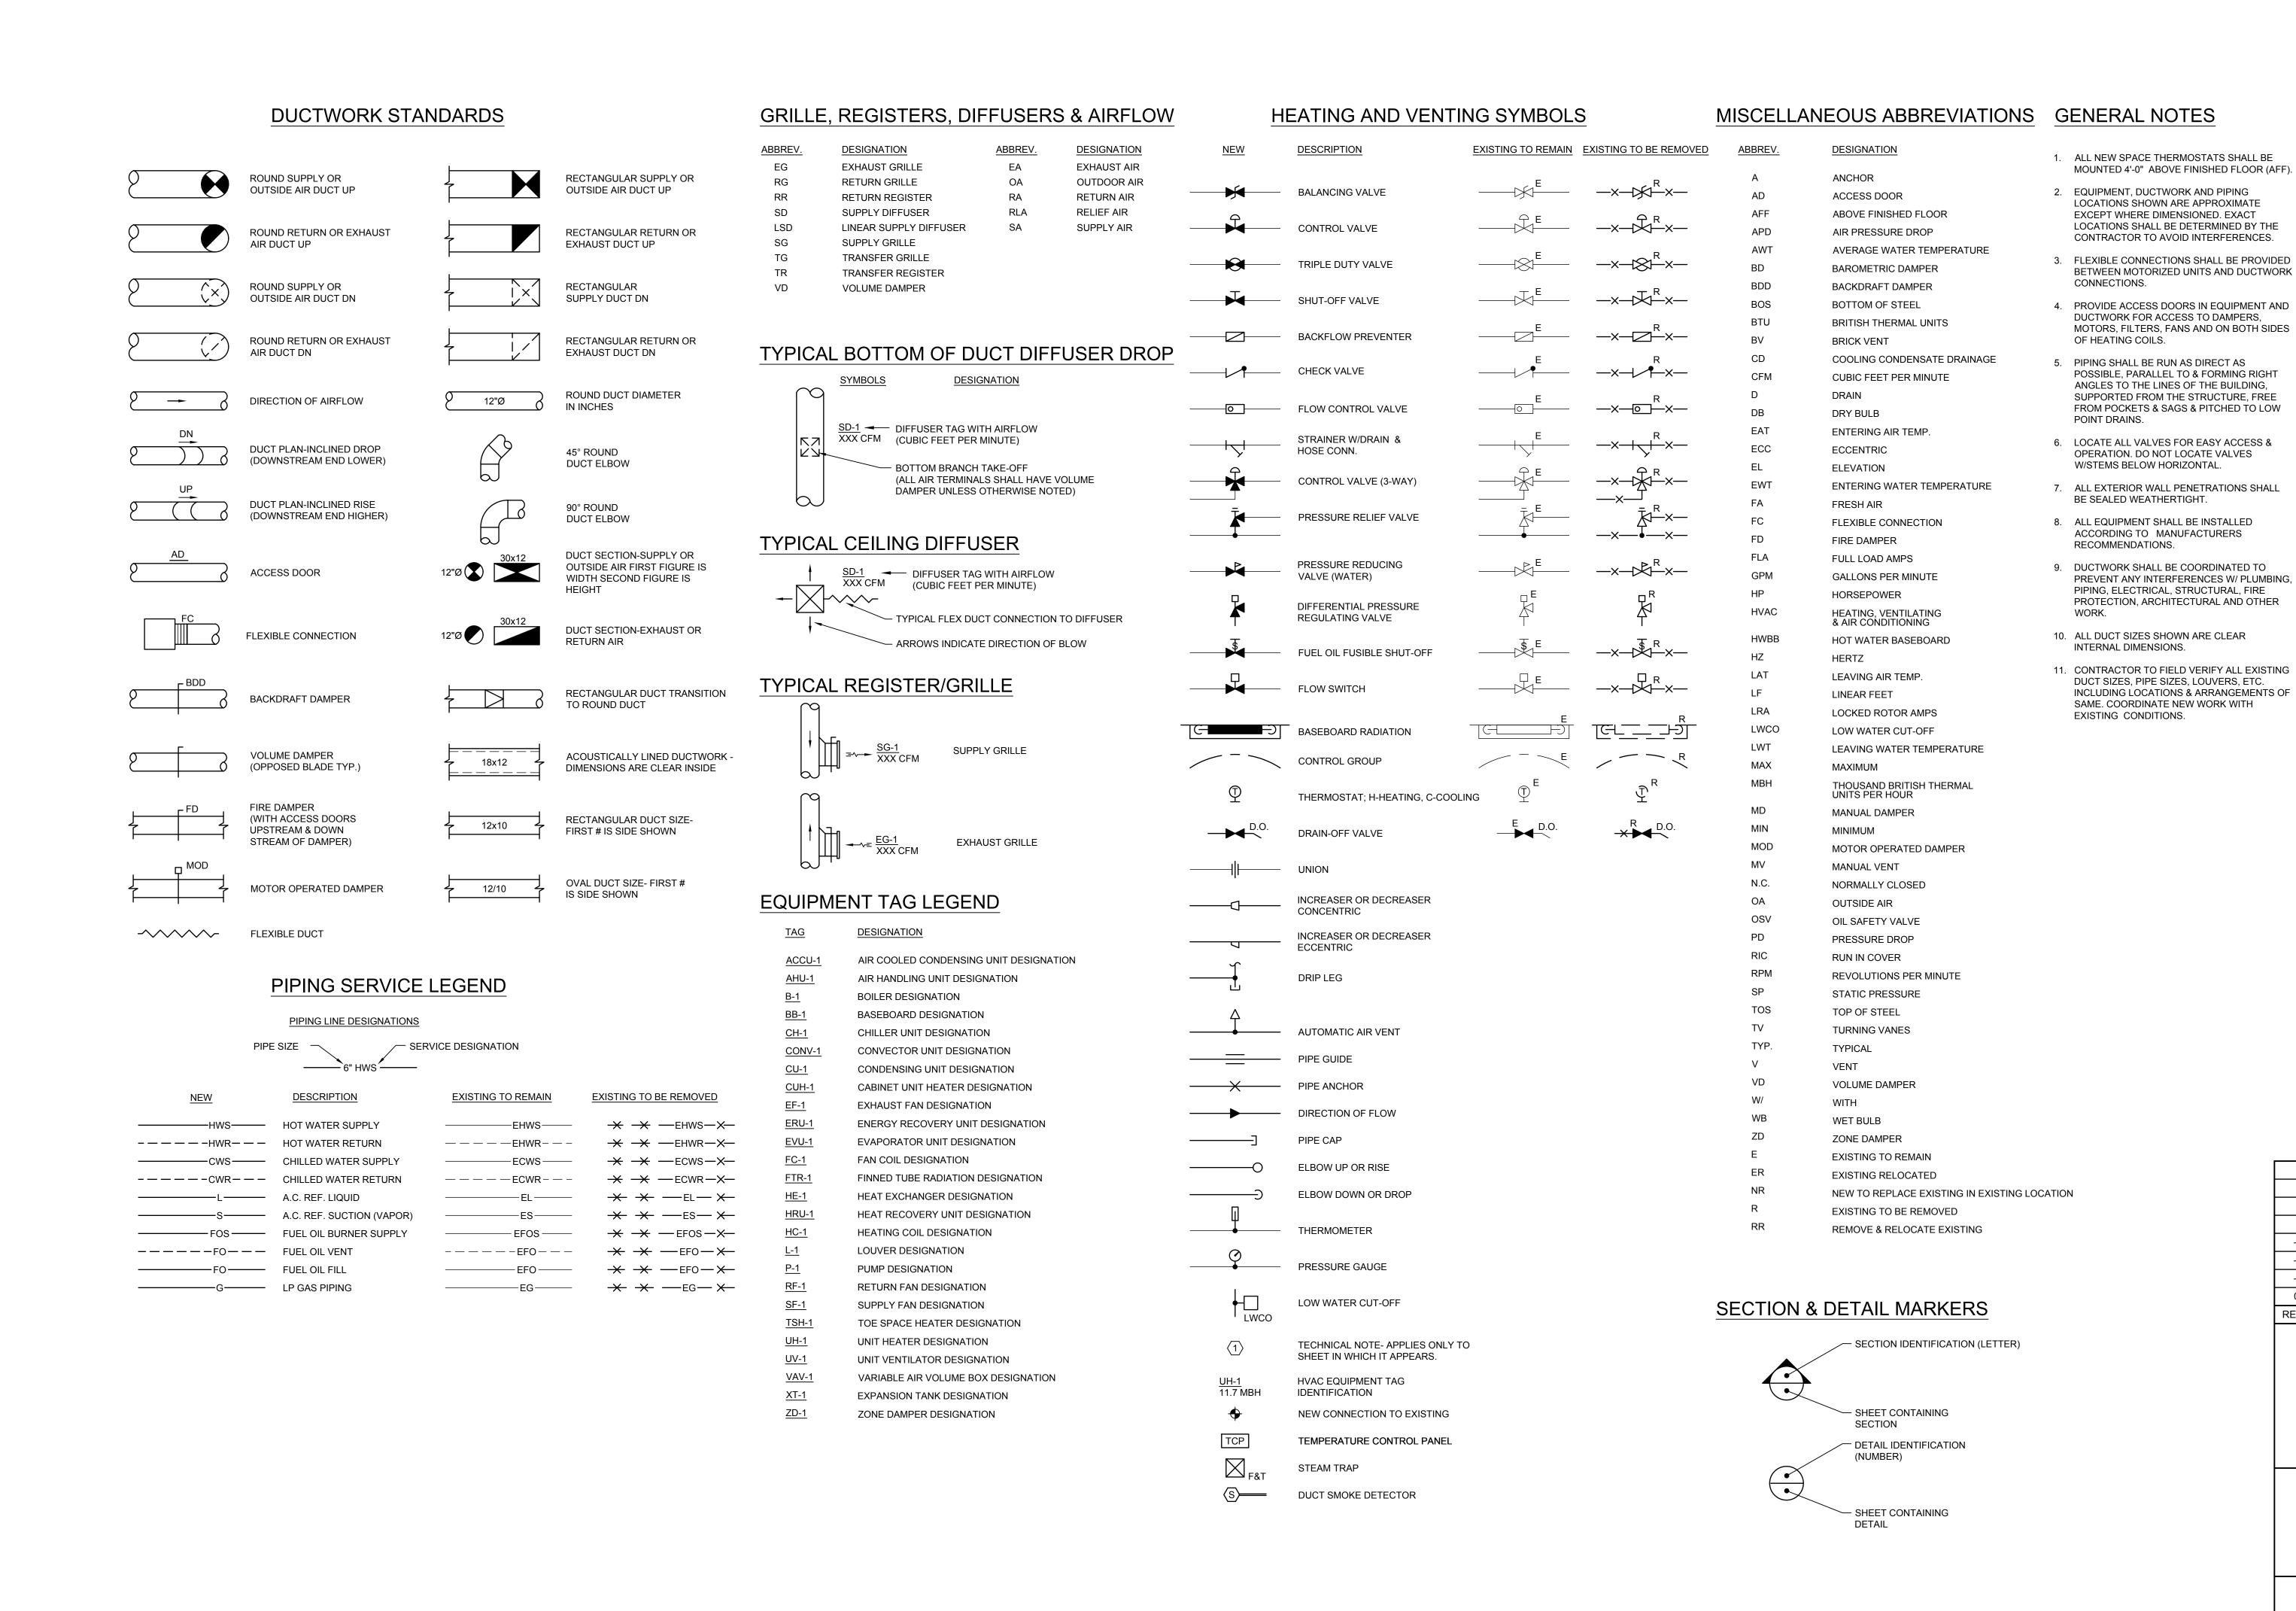
SYMBOL	A D\ /	DESCRIPTION	EXISTING	EXISTING
SYMBOL	ABV.	DESCRIPTION	TO REMAIN	TO BE REMOVED
	— HW	HOT WATER PIPING	EHW—	- <del>×</del> EHW ×
—THW—— — —	— THW	TEPID HOT WATER PIPING (TEMP IN °F)	ETHW-	- <b>→</b> - ETHW <b>→</b>
	— HWR	HOT WATER RETURN PIPING	EHWR-	- <b>→</b> - EHWR <b>→</b>
	cw	COLD WATER PIPING	ECW-	- <b>→</b> ECW <b>→</b>
	w	SANITARY WASTE PIPING	EW	—×——EW——×
	w	SANITARY WASTE PIPING BELOW SLAB	EW—	—×——EW——×
	_ v	VENT PIPING	EV_	-*EV*
CD	— CD	CONDENSATE PIPING	ECD _	- * - ECD *
	— G	L.P. GAS PIPING	EG	— <b>×</b> — — EG — →
RW—	— RW	RAINWATER PIPING	ERW-	— <del>×</del> — — ERW— — ≯
— RW— –	- RW	RAINWATER PIPING BELOW SLAB	ERW_	- <b>×</b> ERW <b>&gt;</b>
)	_	PIPE TURNING UP		
	_	PIPE TURNING DOWN		
ю ф	_	FLOOR CLEANOUT	егсо ф	EFCO \$X
0 1	_	WALL OR END OF LINE CLEANOUT	ECO I	ECO I
<u>E-1</u>		EQUIPMENT FIXTURE NUMBER - REFER TO PLUMBING FIXTURE SCHEDULE		
<u>P-5</u>		PLUMBING FIXTURE NUMBER - REFER TO EQUIPMENT FIXTURE SCHEDULE		
<b>⊙</b> FD		FLOOR DRAIN	O FD-E	O <sub>FD-R</sub>
RD		ROOF DRAIN	RD-E	RD-R
	_	SHUT-OFF VALVE	E	R
<b>₩</b>	_	BALANCING VALVE	E	
•	_	CHECK VALVE	E	R
	B.I.P.	BLACK IRON PIPE		
0-+		PLUMBING FIXTURE CONNECTION		
	VTR	VENT THRU ROOF	VTR-E	
	V.I.F.	VERIFY IN FIELD		
	_	BACKFLOW PREVENTER		
		DOMESTIC WATER HEATER	DWH-E	DWH-
(1)		TECHNICAL NOTE, PERTAINS ONLY TO THE	<u> </u>	
	TP	SHEET ON WHICH IT APPEARS.  TRAP PRIMER	TP <sub>E</sub>	
	DU	TRAP PRIMER DISTRIBUTION UNIT	(DU) E	
■ WHA	WHA	WATER HAMMER ARRESTOR	E E	
<u> </u>	V V I I/A	NEW TO EXISTING CONNECTION		

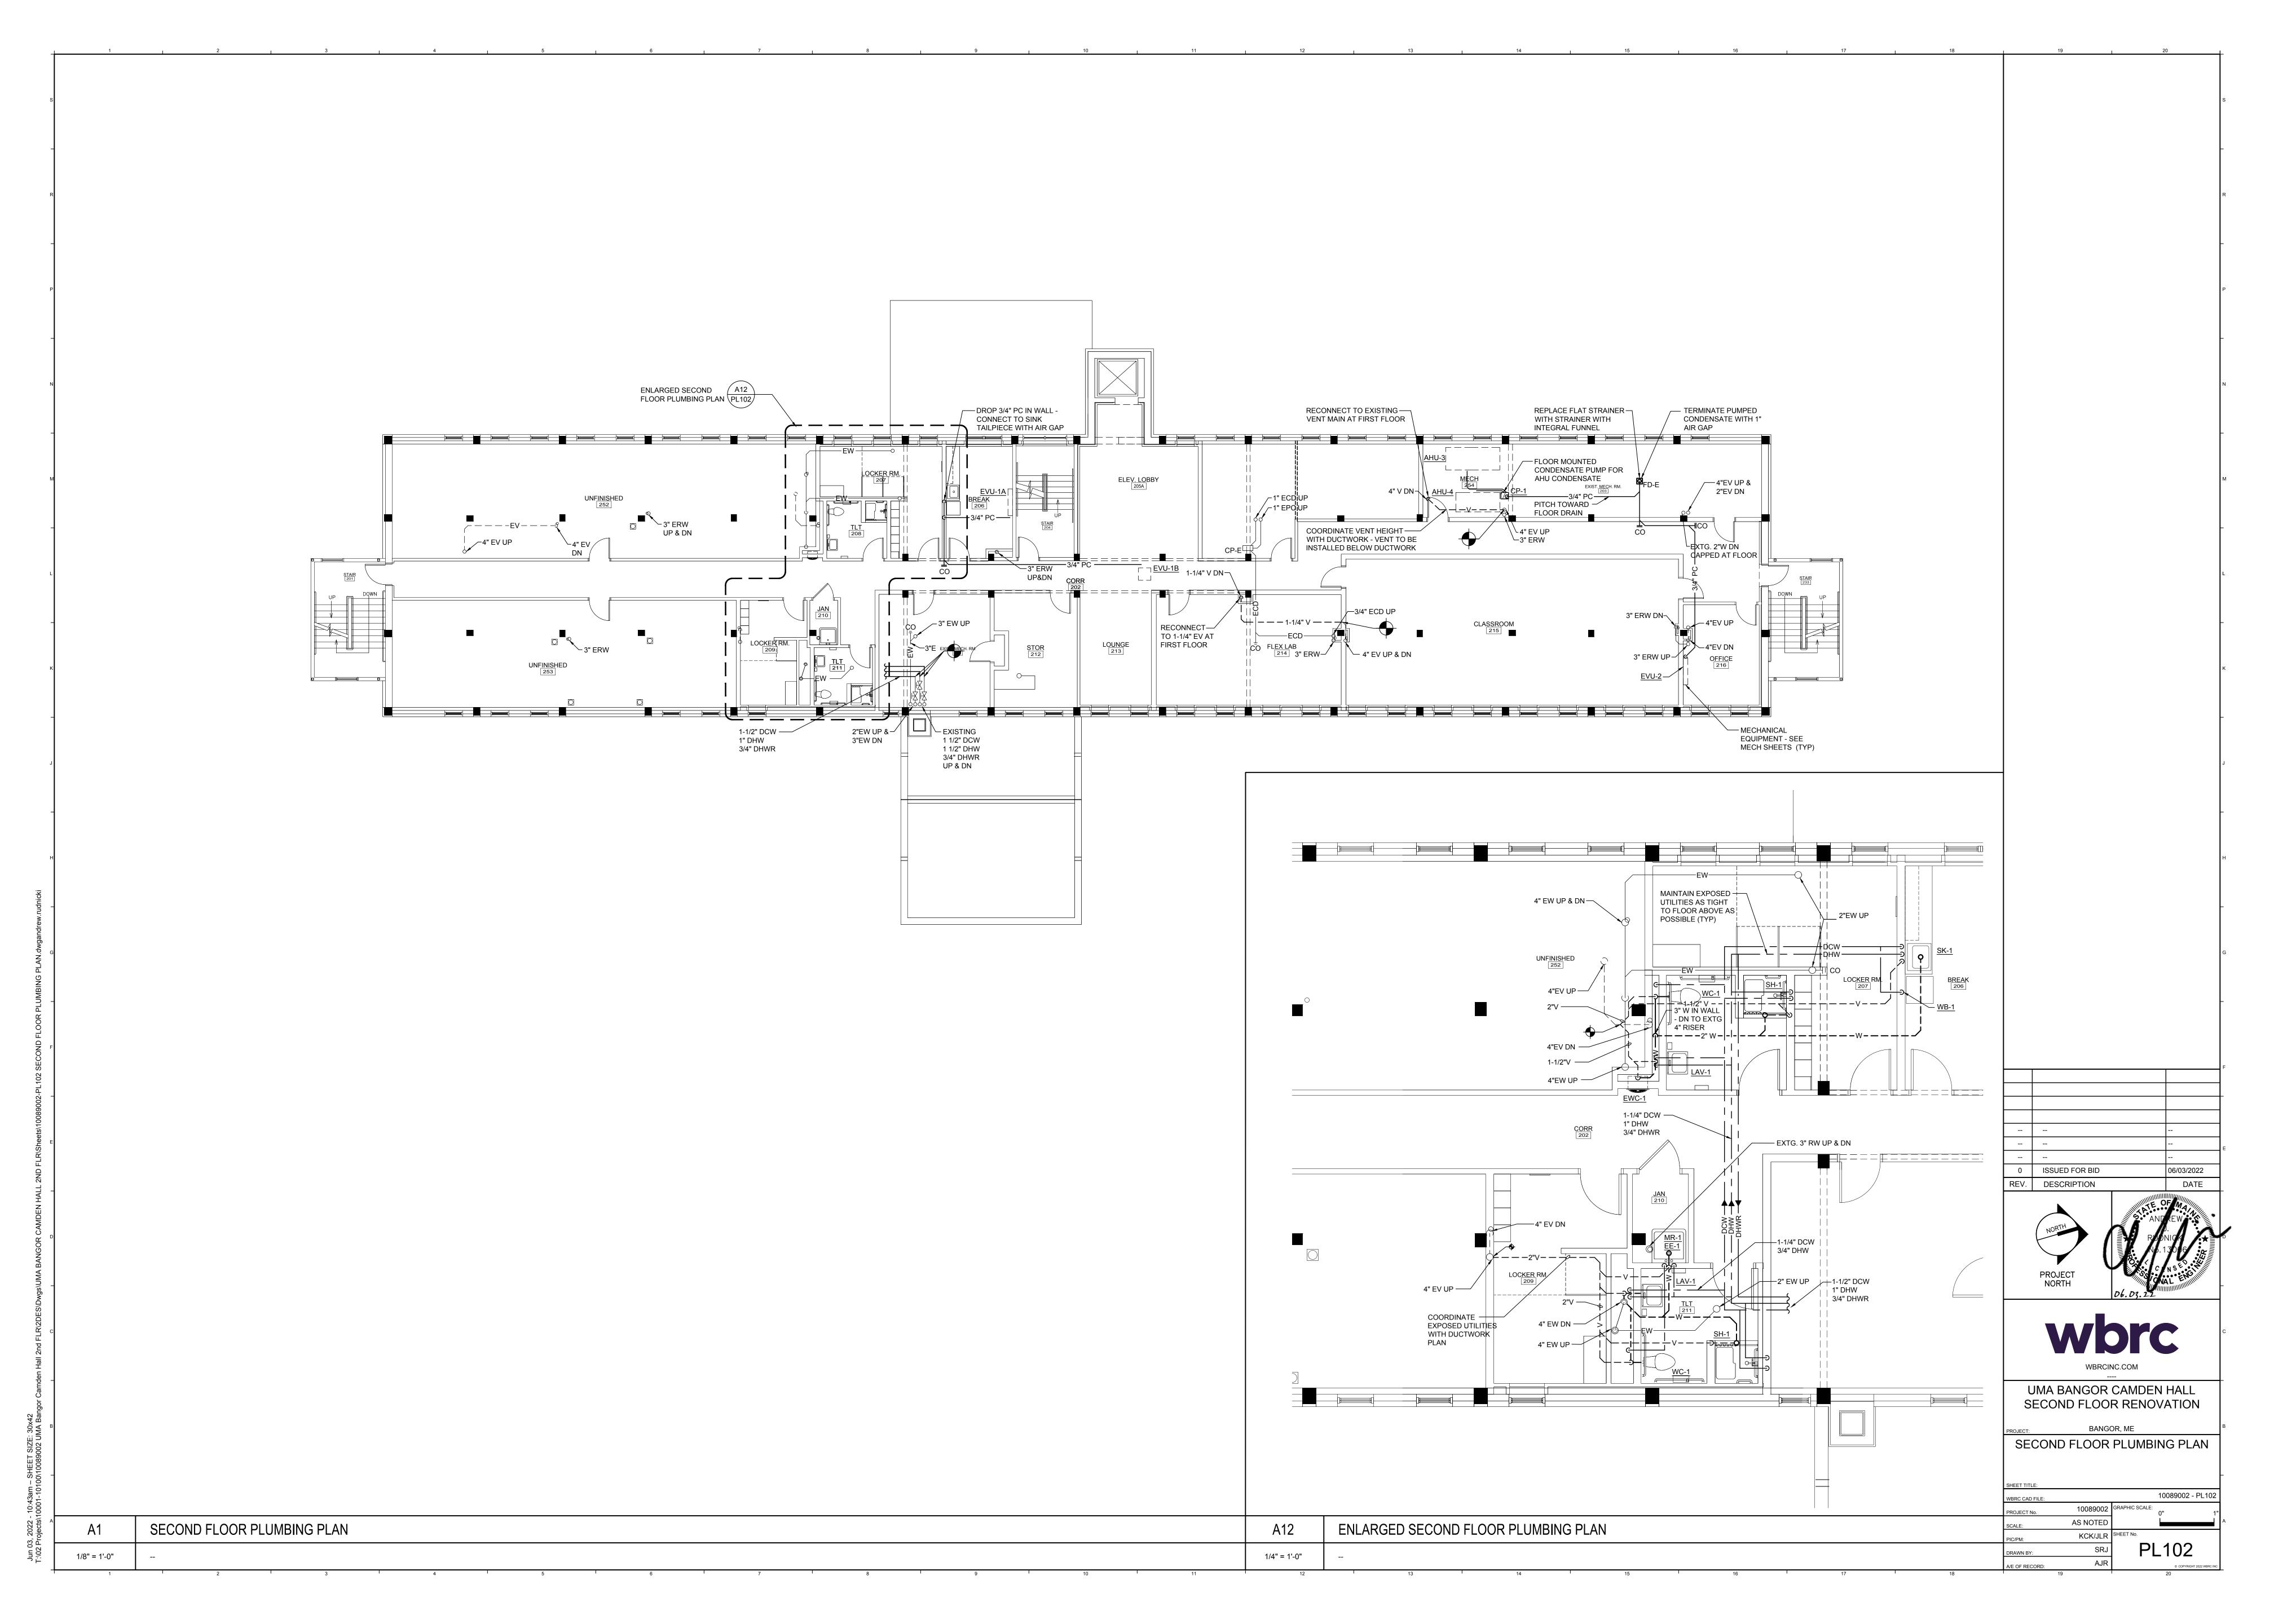		PLUN	/IBING	FIXIL	JRE SC	HEDU	ILE	
TAG	DESCRIPTION	HW	CW	TRAP	WASTE	VENT	MOUNTING HEIGHT	NOTES
WC-1	ADA WALL MOUNTED WATER CLOSET	-	1"	-	3"	2"	17" RIM	
LAV-1	ADA - WALL HUNG LAVATORY	1/2"	1/2"	1-1/4"	1-1/2"	1-1/2"	34" AFF	
SK-1	ADA SINGLE BOWL SINK	1/2"	1/2"	1-1/2"	1-1/2"	1-1/2"	COUNTER	COORDINATE WITH BREAK ROOM CASEWORK
SH-1	ADA SHOWER	1/2"	1/2"	2"	2"	1-1/2"	SEE ARCH.	
MR-1	MOP RECEPTOR	1/2"	1/2"	3"	3"	2"	FLOOR	
EE-1	WALL MOUNTED EMERGENCY EYEWASH DRENCH HOSE	1/2"	1/2"	-	-	-	48" AFF	LOCATE WITHIN 12" OF MOP RECEPTOR
EWC-1	WALL RECESSED BOTTLE FILL STATION	-	1/2"	1-1/4"	1-1/2"	1-1/2"	SEE ARCH	
WB-1	REFRIGERATOR WALL BOX	_	1/2"	_	_	_	48" AFF	

		PLUN	IBING PUM	P SCH	EDULE	<b>-</b>			
TAG	SERVES	MODEL	TYPE	PEAK GPM	HEAD		ELECTRICA	L	NOTES
				GPIVI	FT	HP	VOLT	PHASE	
CP-1	AHU-1 & 2 CONDENSATE	VCMA-20	CONDENSATE	50	10	1/30	115	1	1, 2
I. BASED C	PUMP SCHEDULE NOTES: N LITTLE GIANT L FLOAT, (3) 1-1/8" INLETS, 3/8" BA	ARBED OUTLET, A	AND INTEGRAL CHECK	VALVE			I		



T:\02 Projects\10001-10100\10089002 UMA Bangor Camden Hall 2nd FLR\2DES\Dwgs\UMA BANGOR CAMDEN HALL 2ND FLR\Sheets\10089002-PL501 PLUMBING DETAILS & S

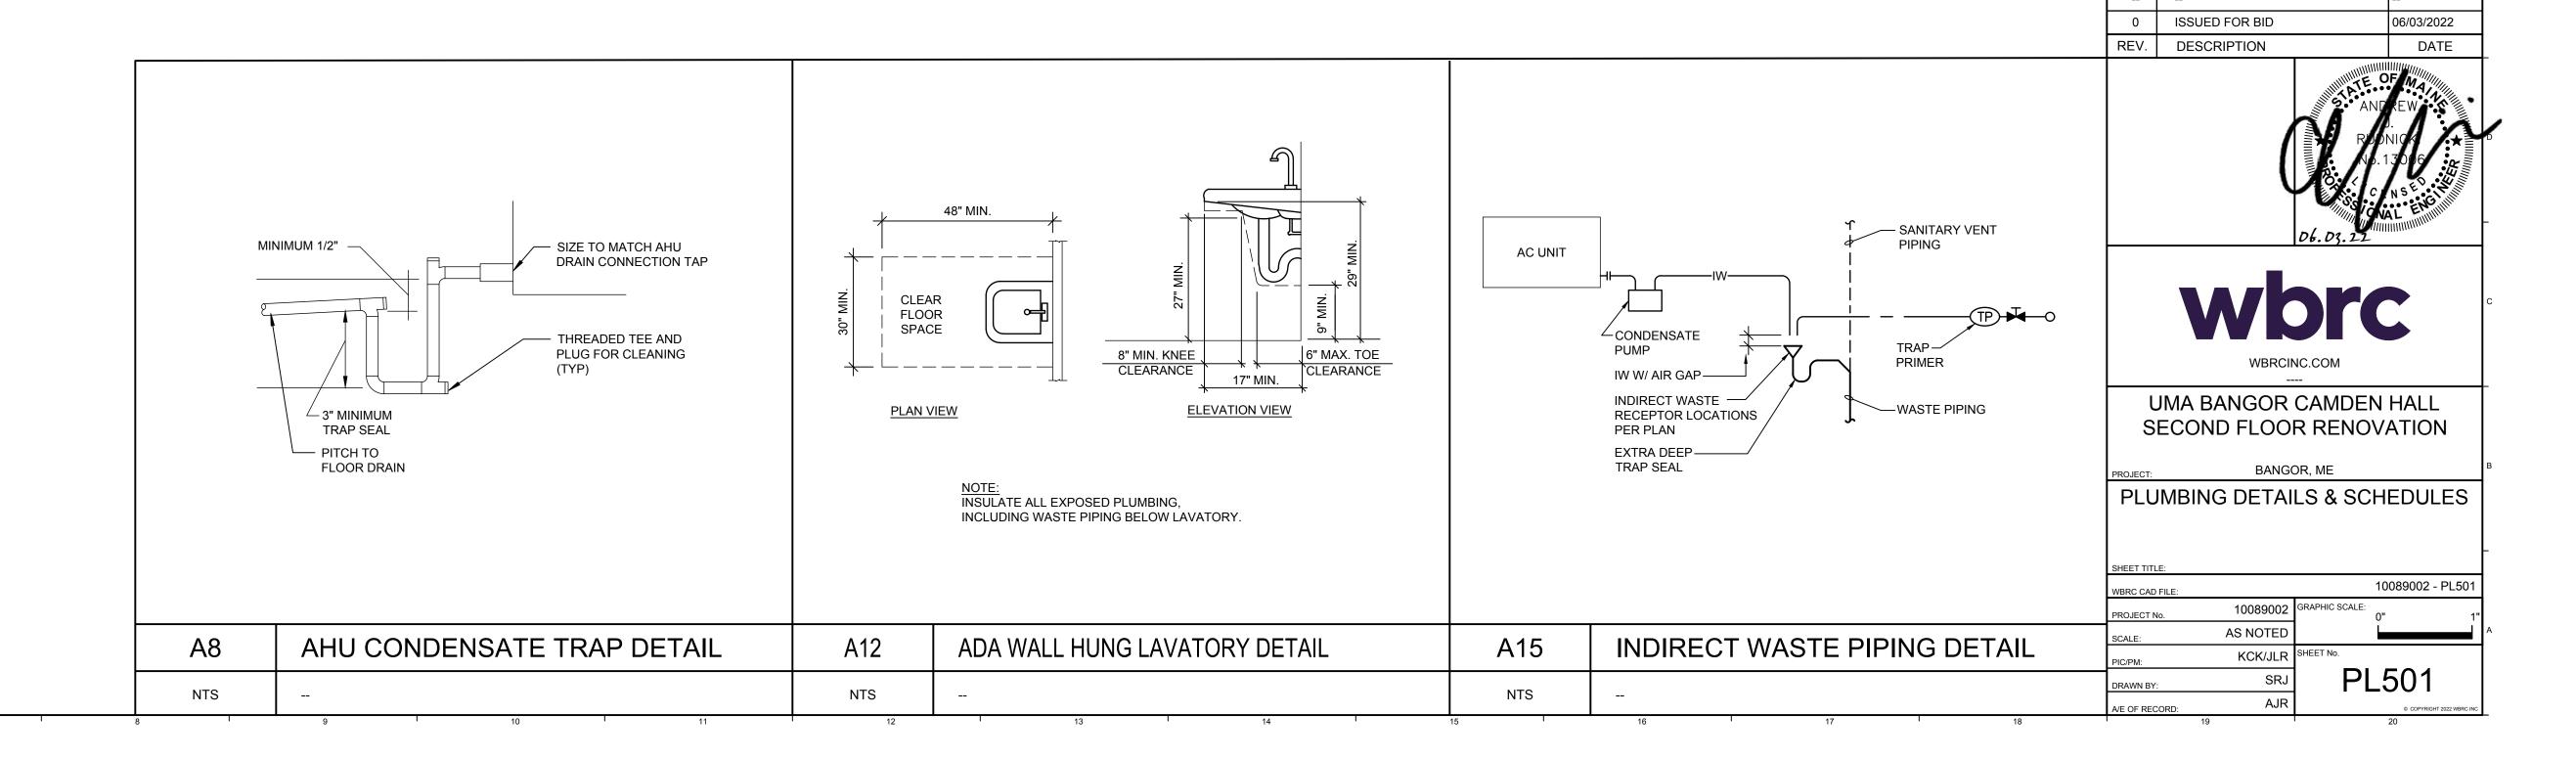




UMA BANGOR CAMDEN HALL SECOND FLOOR RENOVATION


BANGOR, ME MECHANICAL LEGEND

10089002 - M-001 AS NOTED KCK/JLR SHEET No.

M-001

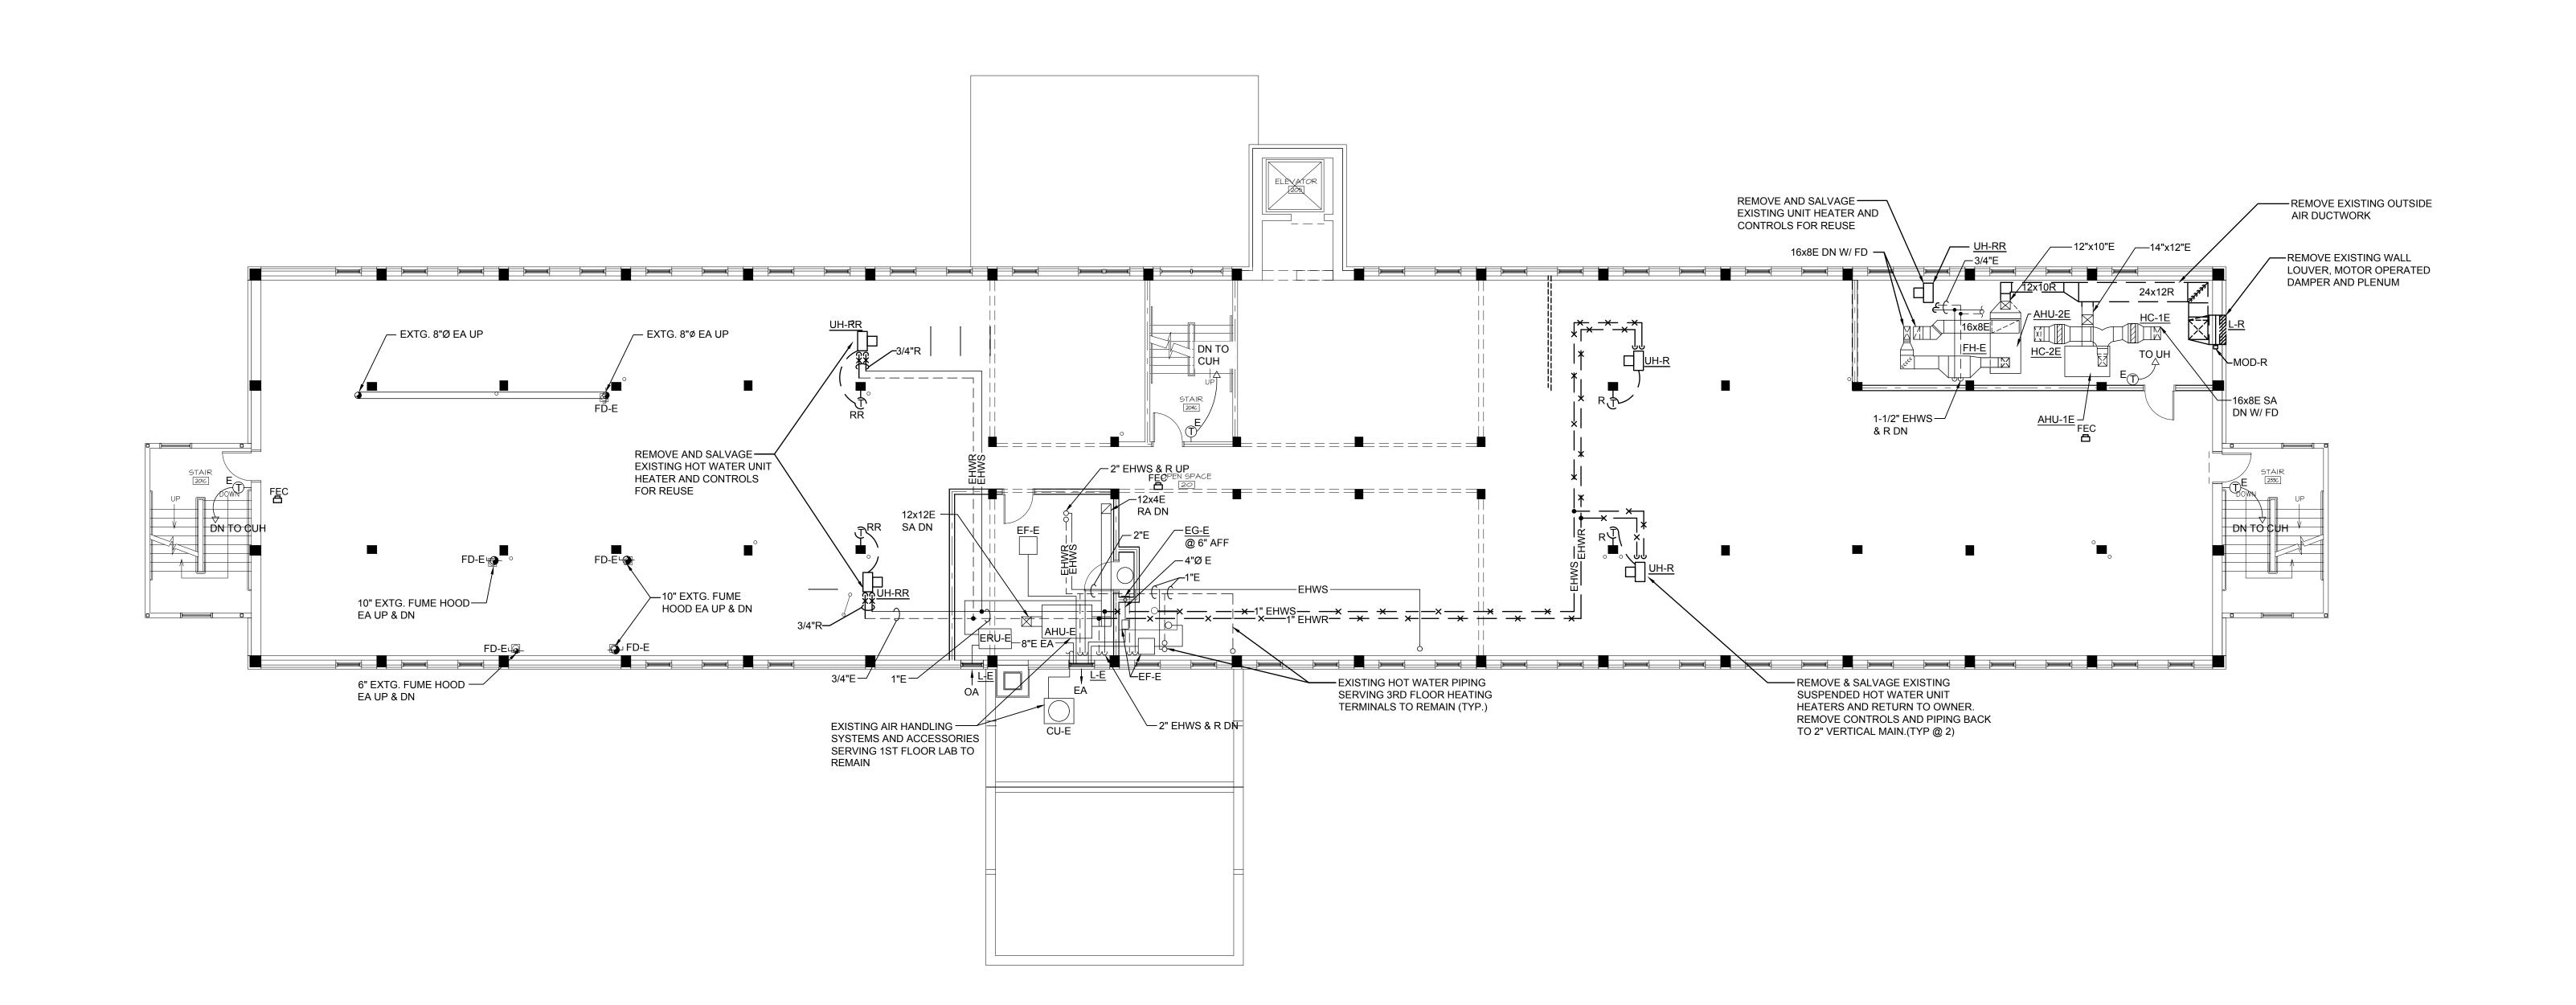



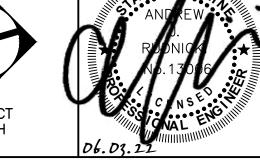

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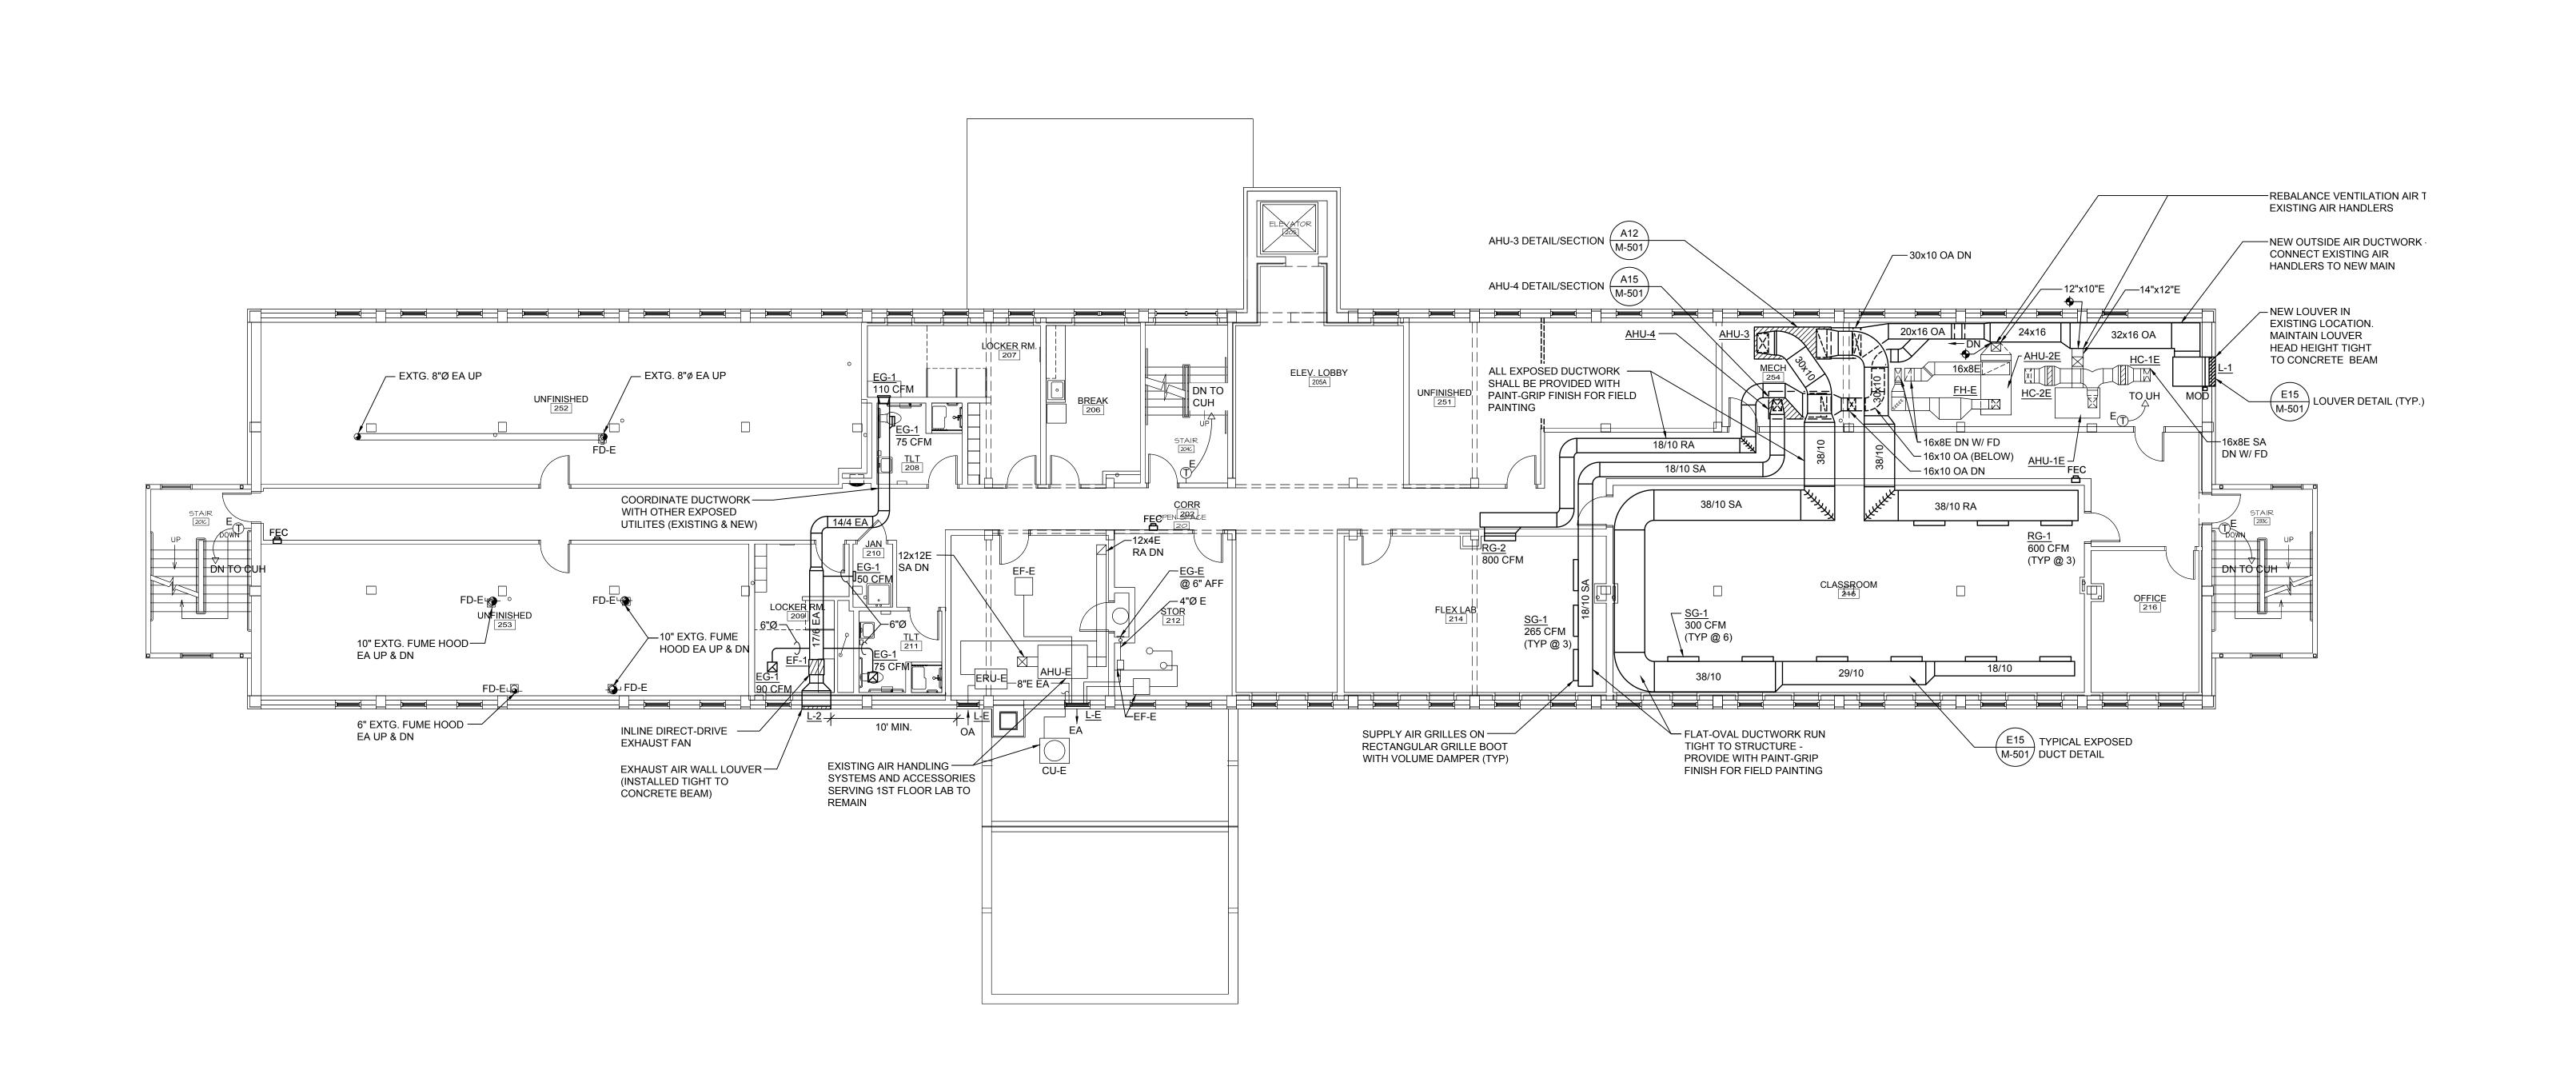
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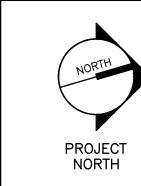
BANGOR, ME SECOND FLOOR MECHANICAL REMOVALS PLAN


10089002 - MD102 AS NOTED

KCK/JLR SHEET No. MD102

SECOND FLOOR MECHANICAL REMOVALS PLAN 1/8" = 1'-0"





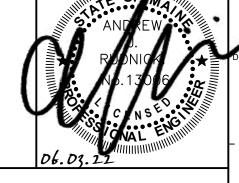

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UMA BANGOR CAMDEN HALL SECOND FLOOR RENOVATION

BANGOR, ME SECOND FLOOR MECHANICAL **DUCTWORK PLAN** 


10089002 - MH102

AS NOTED KCK/JLR SHEET No.

MH102

1/8" = 1'-0"

SECOND FLOOR MECHANICAL DUCTWORK PLAN

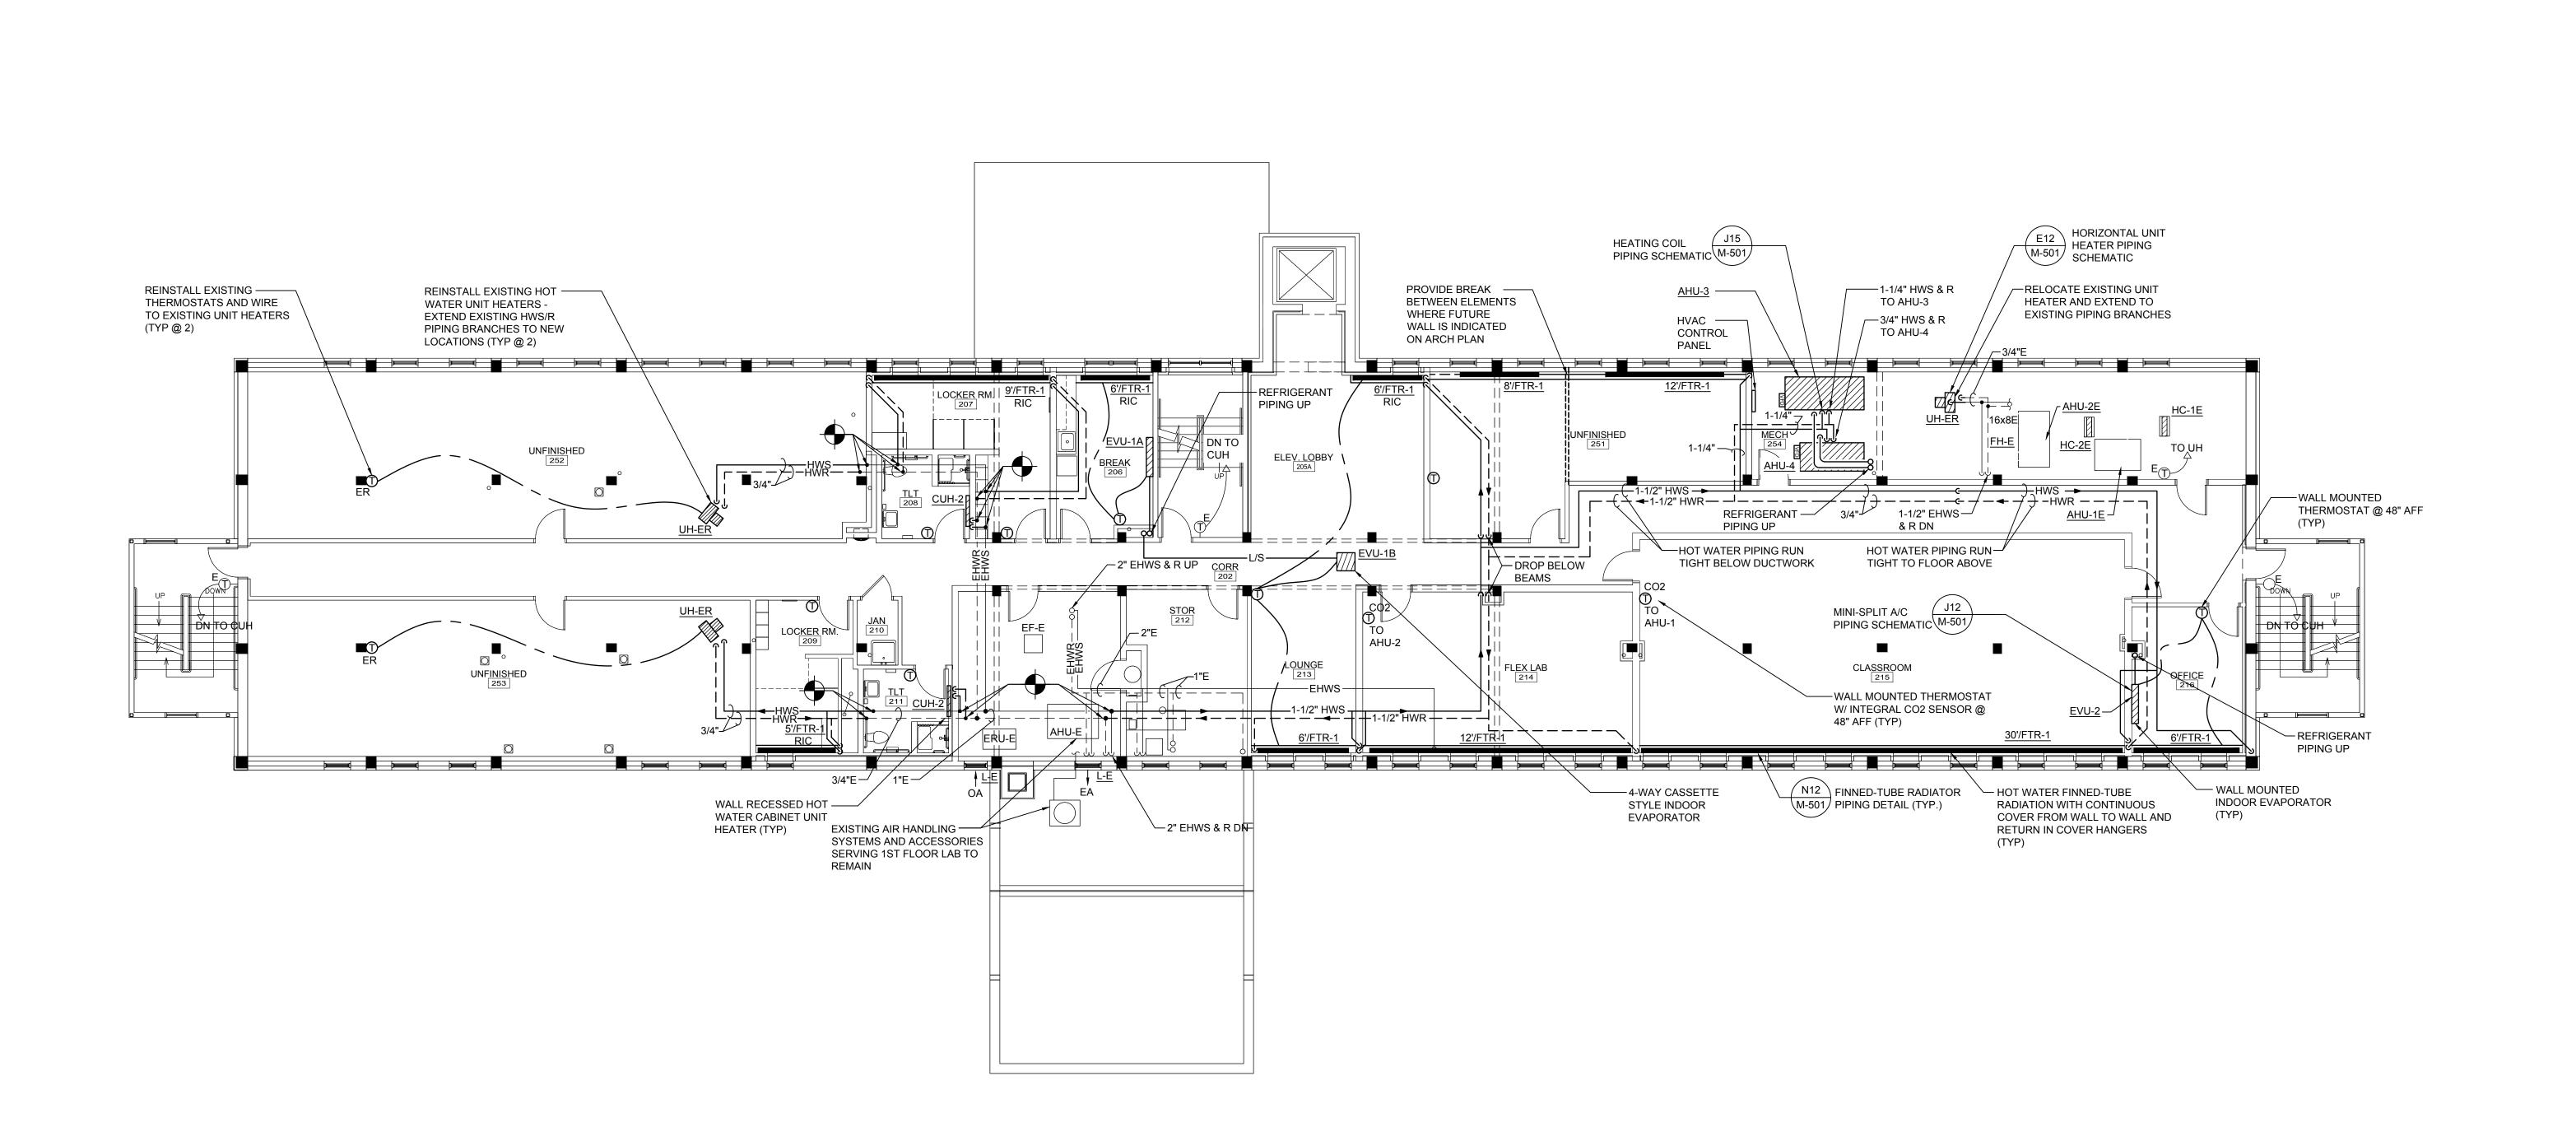


GENERAL NOTES:

1. ALL HOT WATER SUPPLY AND RETURN BRANCHES OUT TO TERMINAL HEATING EQUIPMENT SHALL BE 3/4" UNLESS NOTED OTHERWISE

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UMA BANGOR CAMDEN HALL SECOND FLOOR RENOVATION


BANGOR, ME SECOND FLOOR MECHANICAL PIPING PLAN

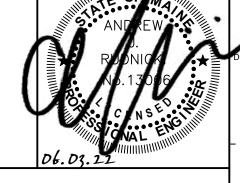
10089002 - MP102


AS NOTED KCK/JLR SHEET №.

1/8" = 1'-0"

SECOND FLOOR MECHANICAL PIPING PLAN

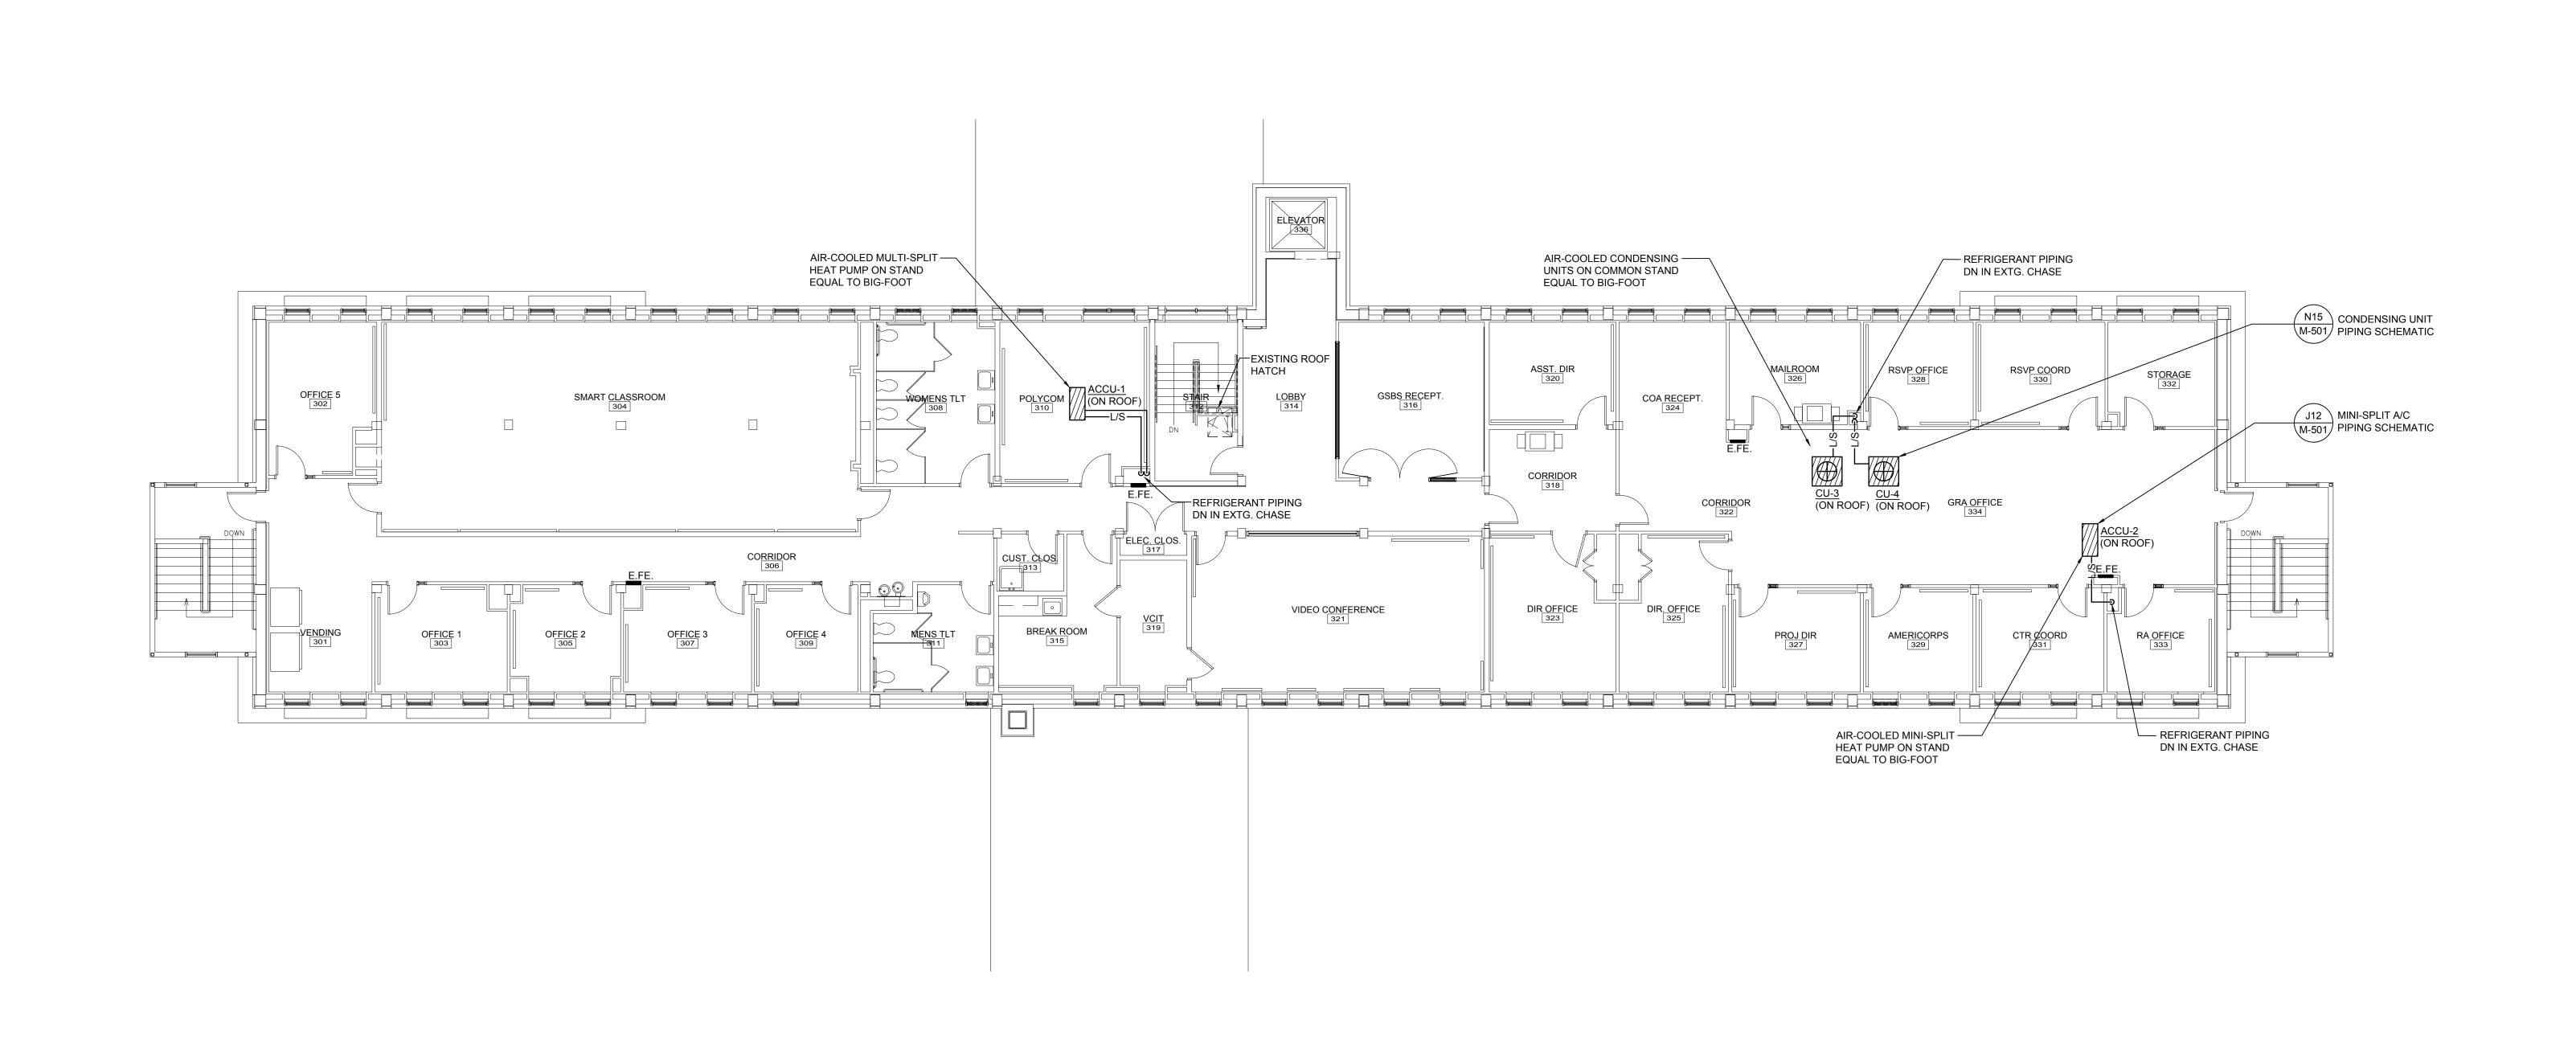

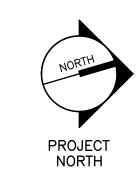

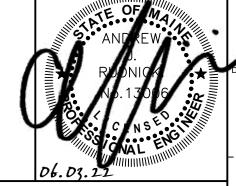

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UMA BANGOR CAMDEN HALL SECOND FLOOR RENOVATION


BANGOR, ME THIRD FLOOR MECHANICAL PIPING PLAN

10089002 - MP103

AS NOTED KCK/JLR SHEET No.

1/8" = 1'-0"

THIRD FLOOR MECHANICAL PIPING PLAN

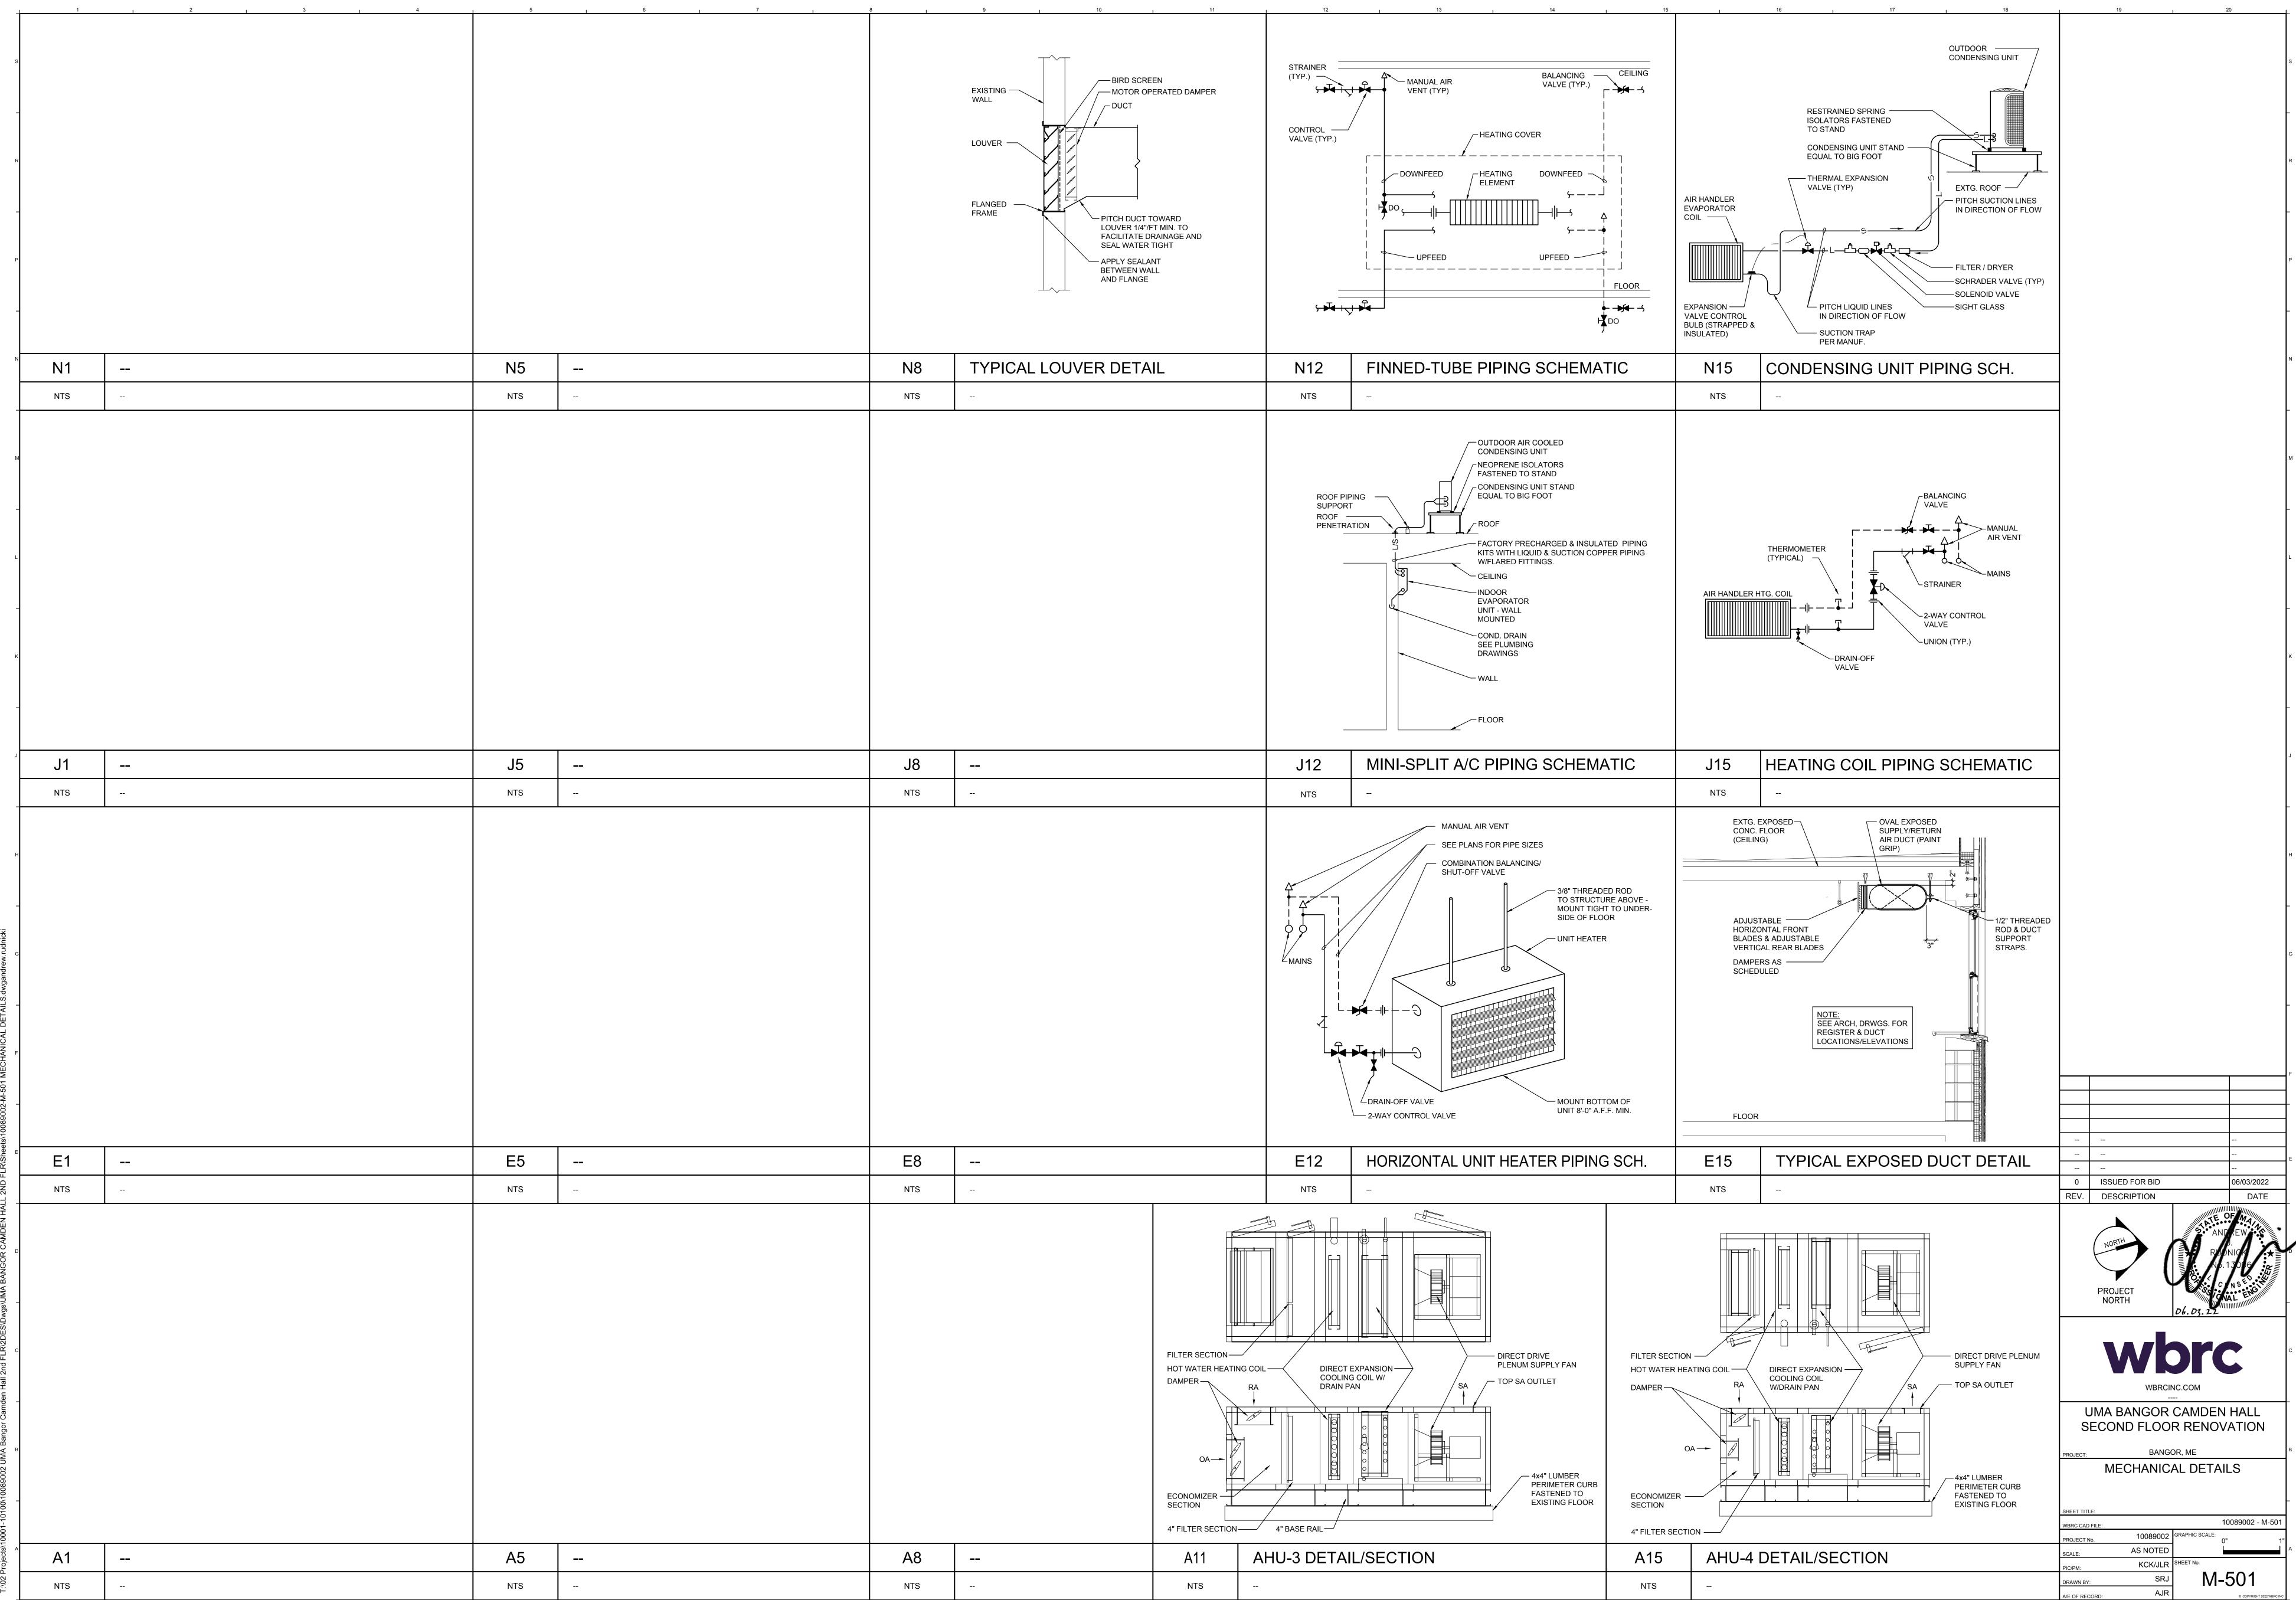

Jun 03, 2022 - 10:16am – SHEET SIZE: 30x42

AIR HANDLING UNIT SCHEDULE

SUPPLY FAN

	FAN SCHEDULE											
TAG	SERVES	TYPE		CFM	CFM ESP	FAN RPM	ELECTRICAL			WEIGHT LBS.	NOTES	
					114-446	IXFIVI	HP	VOLTS	PHASE	LDO.		
EF-1	LOCKER/TOILET ROOMS	INLINE EXHAUST FAN	CSP-A510-VG	400	0.50	1,248	104 W	120	1	43	1, 2, 3, 4, 5	

#### FAN SCHEDULE NOTES:

- . BASED ON GREENHECK
- 2. ECM MOTOR WITH SPEED KNOB ON MOTOR . BACKDRAFT DAMPER
- . ISOLATION KIT
- . GALVANIZED HOUSING AND WHEEL

	HEATER SCHEDULE												
TAG												NOTES	
								<sup>-</sup> F	HP	VOLT	PHASE		
CUH-1	TOILET ROOM 208	WALL RECESSED	W42	53	4.2	1.0	0.2	180	1/30	120	1	1, 2, 3	
CUH-2	TOILET ROOM 211	WALL RECESSED	W42	53	4.2	1.0	0.2	180	1/30	120	1	1, 2, 3	
UNIT HEAT	JNIT HEATER SCHEDULE NOTES:												

1. BASED ON BEACON MORRIS 2. PROVIDE COLOR AS SELECTED BY ARCHITECT

3. WALL RECESS KIT

				MINI SPI	LIT SYST	EM AC S	CHEDULE			
	COOLING	HEATING	ALDEL OVA	ELECT	ELECTRICAL		IPE CONN.			
UNIT	CAPACITY (BTU/H)	CAPACITY (BTU/H)	AIRFLOW CFM	VOLTS	AMPS	LIQUID	SUCTION	WEIGHT	MODEL NO.	SERVES
EVU-1A	7,800	7,900	381	208/1	1.0	1/4	3/8	20	FTXS09LVJU	BREAK
EVU-1B	15,600	15,800	420	208/1	1.0	1/4	1/2	36	FFQ15Q2VJU	LOBBY/LOUNGE
EVU-2	9,000	10,000	431	208/1	1.0	1/4	3/8	20	FXZQ12TAVJU	OFFICE
UNIT	COOLING CAPACITY	SEER	СОР	REFG		ELECTRICAL		WEIGHT	MODEL NO.	NOTES
	(BTU/H)				VOLTS	MCA	MAX FUSE			
ACCU-1	24,000	18	3.52	R-410A	208/1	21.6	25	137	3MXS24RMVJUA	1, 2, 3, 4, 5
ACCU-2	9,000	19	4.06	R-410A	208/1	8.7	15	57	RX09AXVJU	1, 2, 4, 5

# MINI SPLIT SYSTEM SCHEDULE NOTES:

- BASED ON DAIKIN
- 2. PROVIDE WITH 16" HIGH ADJUSTABLE STEEL STAND EQUAL TO BIGFOOT. 3. FACTORY INSTALLED CONDENSATE LIFT PUMP.
- 4. FIELD INSTALLED CONDENSATE PUMP BELOW EVAPORATOR COVER EQUAL TO ASPEN MINI-BLANC

5. PROVIDE WITH WIRED THERMOSTAT WITH LCD DISPLAY

DIFFUSER / GRILLE AND REGISTER SCHEDULE												
DESCRIPTION    NECK   SIZE   OFM   SIZE   OFM   SIZE   OFM   OFF   OFF												
SUPPLY AIR GRILLE	18 x 8	400	0.035	12 - 18 - 29	<15	DBL. DEFLECTION	520-N-L	SURFACE	1, 2, 3, 4			
RETURN AIR GRILLE	32 x 8	600	0.040	-	<15	45° DEFLECTION	530-N-L	SURFACE	1, 2			
RETURN AIR GRILLE	40 x 8	800	0.040	-	<15	45° DEFLECTION	530-N-L	SURFACE	1, 2			
EXHAUST AIR GRILLE	8 x 6	125	0.063	-	<15	45° DEFLECTION	530-N-L	SURFACE	1, 2			
	SUPPLY AIR GRILLE  RETURN AIR GRILLE  RETURN AIR GRILLE	DESCRIPTION  DESCRIPTION  SIZE (W x H)  SUPPLY AIR GRILLE  18 x 8  RETURN AIR GRILLE  32 x 8  RETURN AIR GRILLE  40 x 8	DESCRIPTION         NECK SIZE (W x H)         MAX CFM           SUPPLY AIR GRILLE         18 x 8         400           RETURN AIR GRILLE         32 x 8         600           RETURN AIR GRILLE         40 x 8         800	DESCRIPTION         NECK SIZE (W x H)         MAX CFM         SP (IN-WC)           SUPPLY AIR GRILLE         18 x 8         400         0.035           RETURN AIR GRILLE         32 x 8         600         0.040           RETURN AIR GRILLE         40 x 8         800         0.040	DESCRIPTION         NECK SIZE (W x H)         MAX CFM         SP (IN-WC)         THROW FT           SUPPLY AIR GRILLE         18 x 8         400         0.035         12 - 18 - 29           RETURN AIR GRILLE         32 x 8         600         0.040         -           RETURN AIR GRILLE         40 x 8         800         0.040         -	DESCRIPTION         NECK SIZE (W x H)         MAX CFM         SP (IN-WC)         THROW FT         NC           SUPPLY AIR GRILLE         18 x 8         400         0.035         12 - 18 - 29         <15	DESCRIPTION         NECK SIZE (W x H)         MAX CFM         SP (IN-WC)         THROW FT         NC         TYPE           SUPPLY AIR GRILLE         18 x 8         400         0.035         12 - 18 - 29         <15	DESCRIPTION         NECK SIZE (W x H)         MAX CFM         SP (IN-WC)         THROW FT         NC         TYPE         MODEL           SUPPLY AIR GRILLE         18 x 8         400         0.035         12 - 18 - 29         <15	DESCRIPTION         NECK SIZE (W x H)         MAX CFM         SP (IN-WC)         THROW FT         NC         TYPE         MODEL         MOUNTING           SUPPLY AIR GRILLE         18 x 8         400         0.035         12 - 18 - 29         <15			

DIFFUSER / GRILLE SCHEDULE NOTES: 1. BASED ON PRICE

2. PROVIDE WHITE FINISH

LBS PER

CIRCUIT

4.3

NOTES

1, 2, 3

1, 2, 3

EER/SEER

12.5

13

COMPRESSORS

NO. CIRCUITS

1-1/8"

PIPING CONNECTIONS

LIQUID SUCTION

QTY

1/2"

3/8"

REFG

R-410A

3. VOLUME EXTRACTOR (BLADES 2" O.C.) WITH KEY ADJUSTMENT THROUGH FACE OF GRILLE

4. PERFORMANCE BASED ON 22 DEGREE FRONT BLADE ANGLE

	FINNED-TUBE RADIATOR SCHEDULE													
TAG	TYPE	BTU/FT	PIPING CONN.	GPM	TIERS	FPF	ELEMENT	MODEL	AVG WATER TEMP °F	EAT F	NOTES			
FTR-1	WALL MOUNTED	690	3/4" NPT	1.0	1	50	2 3/4" x 3 3/4" x 0.011"	LB2	170	65	1, 2, 3			

CONDENSING UNIT SCHEDULE

SCROLL SCROLL

WEIGHT

245

MBH

(EA) 5.5

MAX FUSE

FINNED-TUBE RADIATOR SCHEDULE NOTES:

TAG SERVICE

TAG POWER

CU-3 208/3/60

CU-4 208/3/60

1. BASED ON DAIKIN APPLIED 2. REFRIGERANT SERVICE VALVES 3. 2" DEFLECTION SPRING ISOLATORS

AHU-3

QTY

MODEL

RCS06G079C

FAN DIA

KW INPUT

3.1

6.0

ELECTRICAL

AHU-4 DX13SA0363


AIR COOLED CONDENSING UNIT SCHEDULE NOTES:


NOM. TONS

I. BASED ON STERLING 2. PROVIDE COLOR AS SELECTED BY ARCHITECT 3. PROVIDE FULL HEIGHT BACKPLATE & RETURN IN COVER HANGERS

	LOUVER SCHEDULE												
TAG	SERVICE	SIZE (W x H)	MODEL	BLADE TYPE	FREE AREA SF	CFM	FPM	APD	NOTES				
L-1	AIR HANDLER OUTSIDE AIR	36" x 66"	ESD403	DRAINABLE	8.54	4,000	468	0.05	1, 2, 3, 4, 5				
L-2	L-2 TOILET ROOM EXHAUST AIR 24" x 12" ESD403 DRAINABLE 0.70 400 571 0.05 1, 2, 3, 4, 5												
LOINER SCHEDULE NOTES:													

	EGGVERGGERE												
TAG	SERVICE	SIZE (W x H)	MODEL	BLADE TYPE	FREE AREA SF	CFM	FPM	APD	NOTES				
L-1	AIR HANDLER OUTSIDE AIR	36" x 66"	ESD403	DRAINABLE	8.54	4,000	468	0.05	1, 2, 3, 4, 5				
L-2	TOILET ROOM EXHAUST AIR	24" x 12"	ESD403	DRAINABLE	0.70	400	571	0.05	1, 2, 3, 4, 5				
OUVER SC	HEDULE NOTES:												
I. BASED O	N GREENHECK												
2. LOUVER I	BY DIV. 23, COORDINATE WITH ARC	CHITECTURAL ELE	VATIONS.										
B. COLOR A	COLOR AS SELECTED BY ARCHITECT												
. BIRDSCR	. BIRDSCREENS												
. FLANGED	FLANGED FRAME												

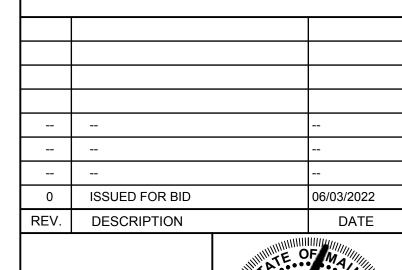

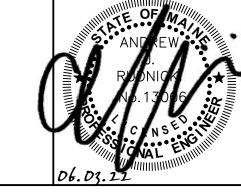



UMA BANGOR CAMDEN HALL SECOND FLOOR RENOVATION

BANGOR, ME MECHANICAL SCHEDULES

10089002 - M-601 10089002 GRAPHIC SCALE:

AS NOTED KCK/JLR SHEET No.

ER EXISTING RELOCATED NR NEW TO REPLACE EXISTING IN EXISTING LOCATION R EXISTING TO BE REMOVED

RR REMOVE & RELOCATE EXISTING

EMERGENCY LIGHT

LED FIXTURE - UPPERCASE LETTER IS TYPE, LOWERCASE LETTER IS SWITCH CONTROL GROUP RECTANGLES INDICATE NUMBER FIXTURES IN A ROW.

CEILING MOUNTED FIXTURE - NOTES SAME AS ABOVE WALL MOUNTED FIXTURE - NOTES SAME AS ABOVE

CEILING MOUNTED EXIT SIGN - ARROW INDICATES DIRECTIVE ARROW ON SIGN

WALL MOUNTED EXIT SIGN - ARROW INDICATES DIRECTIVE ARROW ON SIGN EMERGENCY LIGHTING

BATTERY PACK WITH EMERGENCY LAMPS AS SHOWN REMOTE EMERGENCY LAMP LIGHT FIXTURES

SPST FLUSH WALL TOGGLE SWITCH - MOUNT AT 48" A.F.F TO CENTER - LETTER INDICATES SWITCH GROUP

THREE-WAY TOGGLE SWITCH - NOTES SAME AS SPST SWITCH ABOVE DIMMER SWITCH - NOTES SAME AS SPST SWITCH ABOVE

FOUR-WAY TOGGLE SWITCH - NOTES SAME AS SPST SWITCH ABOVE

WALL KEY SWITCH - NOTES SAME AS ABOVE PILOT LIGHT SWITCH - NOTES SAME AS ABOVE

CEILING MOUNTED OCCUPANCY SENSOR - "H" INDICATES HALLWAY.

20 AMP DUPLEX CONVENIENCE RECEPTACLE - MOUNT AT 18" A.F.F. TO CENTER UNLESS INDICATED OTHERWISE - "GFI" INDICATES GROUND FAULT DEVICE, "\*" INDICATES GFI PROTECTED BY UPSTREAM DEVICE, "WP" INDICATES WEATHERPROOF,

"IG" INDICATES INSULATED/ISOLATED GROUND, "C" INDICATES CEILING MOUNTED, "F" INDICATES FLOOR MOUNTED

20 AMP QUADRAPLEX (DOUBLE DUPLEX) - NOTES SAME AS ABOVE

SPECIAL PURPOSE OUTLET OR EQUIPMENT CONNECTION - COORDINATE LOCATION AND TYPE OF CONNECTION WITH EQUIPMENT BEING SERVED.

JUNCTION BOX WITH COVER

MOTOR - SIZE AS INDICATED - COORDINATE W/ ACTUAL EQUIPMENT BEING SERVED

MANUAL STARTER - COORDINATE WITH EQUIPMENT BEING SERVED SINGLE THROW

FUSED DISCONNECT SWITCH - NEMA ENCLOSURE AS REQUIRED REMOTE CONTROL

MAGNETIC STARTER - COORDINATE W/ EQUIPMENT BEING SERVED

GROUND

BRANCH CIRCUIT RUN IN CEILING OR IN WALLS

ADA ELECTRICALLY-ASSISTED DOOR OPENER PUSHBUTTON

—-—- LOW VOLTAGE OR CONTROL WIRING - #12 MINIMUM OR AS NOTED

— # MULTI-CONDUCTOR BRANCH CIRCUIT - NUMBER OF HASHMARKS IS NUMBER OF WIRES (NOT INCLUDING GROUND WIRE) WITHOUT HASHMARKS IS TWO WIRE

HOMERUN TO CIRCUIT AND PANEL INDICATED - NUMBER OF ARROWS IS NUMBER OF PHASE WIRES -NUMBER OF WIRES AS INDICATED ABOVE

— CONTINUATION OF CIRCUIT

→ DIRECTIVE ARROW

PANELBOARD - SEE PANELBOARD SCHEDULE(S)

COMBINATION VOICE/DATA JACK - "V" INDICATES NUMBER OF VOICE LINES, "D" INDICATES NUMBER OF DATA LINES, PROVIDE (1) EACH UNLESS NOTED OTHERWISE - "U" INDICATES 48" TO CENTER A.F.F. CABLING, JACKS, & TERMINATIONS WILL BE PROVIDED AND INSTALLED BY OWNER'S VENDOR. PROVIDE 1" EMPTY CONDUITS WITH PULL STRING WHERE NOT IN CABLE TRAY AND JUNCTION BOXES ONLY.

VOICE JACK - NOTES SAME AS VOICE/DATA JACK ABOVE - "W" INDICATES WALL PHONE, (1) VOICE LINE ONLY DATA JACK - NOTES SAME AS VOICE/DATA JACK ABOVE

WIRELESS ACCESS PORT - CABLING, JACKS, & TERMINATIONS WILL BE PROVIDED AND INSTALLED BY OWNER'S TELEVISION JACK - NOTES SAME AS RECEPTACLES

RECESSED FLOOR OR CEILING MOUNTED BOX - POWER & COMMUNICATIONS AS SHOWN-"F" INDICATES FLOOR MOUNTED, "C" INDICATES CEILING MOUNTED - NOTES SAME AS VOICE/DATA JACK ABOVE

CEILING SPEAKER (SOUND OR INTERCOM SYSTEM AS SHOWN) WALL SPEAKER (SOUND OR INTERCOM SYSTEM AS SHOWN)

LOUD SPEAKER

MICROPHONE

INTERCOM SYSTEM CALL STATION

INTERCOM SYSTEM CONTROL PANEL TELEPHONE/INTERCOM SYSTEM HAND SET

FIRE ALARM SYSTEM CONTROL PANEL

FIRE ALARM ANNUNCIATOR

FIRE ALARM SYSTEM CEILING MOUNTED HEAT DETECTOR

FIRE ALARM SYSTEM CEILING MOUNTED SMOKE DETECTOR

FIRE ALARM SYSTEM DUCT MOUNTED SMOKE DETECTOR WALL MOUNTED FIRE ALARM SYSTEM MANUAL PULL STATION

FIRE ALARM SYSTEM WALL MOUNTED AUDIO/VISUAL DEVICE WITH VISUAL DEVICE CANDELA RATING AS NOTED

FIRE ALARM SYSTEM WALL MOUNTED VISUAL DEVICE ONLY - CANDELA RATING AS NOTED FIRE ALARM SYSTEM DOOR HOLD-OPEN DEVICE CONNECTION

FIRE ALARM SYSTEM/SPRINKLER SYSTEM PRESSURE SWITCH

FIRE ALARM SYSTEM/SPRINKLER SYSTEM FLOW SWITCH

FIRE ALARM SYSTEM/SPRINKLER SYSTEM TAMPER SWITCH SECURITY ALARM SYSTEM CONTROL PANEL

ACCESS CONTROL SYSTEM CARD READER

SECURITY ALARM SYSTEM MOTION DETECTOR

SECURITY ALARM SYSTEM SIREN/STROBE

VIDEO SURVEILLANCE CAMERA

			LIGHT	FIXTURE S	CHEDU	ILE				
TYPE	DESCRIPTION	SIZE	MANUFACTURER CAT. NO.	LENS/LOUVER	LAMPS	DRIVER	MINIMUM EFFICACY	WATTS PER FIXTURE	VOLT.	NOTES
Α	SURFACE MOUNTED FLAT PANEL	2x4	COLUMBIA LIGHTING CFP24-LSCS/SRPSMK-24	FROSTED ACRYLIC	LED	0-10V DIMMING LED	122	49	UNV.	FIXTURE TO SET TO 5500LM OUTPUT AND 3500K COLOR TEMP.
A1	SURFACE MOUNTED FLAT PANEL	2x4	COLUMBIA LIGHTING CFP24-LSCS/SRPSMK-24	FROSTED ACRYLIC	LED	0-10V DIMMING LED	129	33	UNV.	FIXTURE TO SET TO 4100LM OUTPUT AND 3500K COLOR TEMP.
В	SURFACE MOUNTED FLAT PANEL	2x2	COLUMBIA LIGHTING CFP22-LSCS/SRPSMK-22	FROSTED ACRYLIC	LED	0-10V DIMMING LED	128	28	UNV.	FIXTURE TO SET TO 3300LM OUTPUT AND 3500K COLOR TEMP.
B1	CEILING RECESSED FLAT PANEL	2x2	COLUMBIA LIGHTING CFP22-LSCS	FROSTED ACRYLIC	LED	0-10V DIMMING LED	128	28	UNV.	FIXTURE TO SET TO 3300LM OUTPUT AND 3500K COLOR TEMP.
С	WALL MOUNTED LINEAR	4'L	LITECONTROL 4L-W-AD-4-04-ASYM-C*-35K-D110-D01-1C-UNV	ASYM. DIFFUSED ACRYLIC	LED	0-10V DIMMING LED	110	40	UNV.	FIXTURE TO BE MOUNTED AT 8'-0" AFF TO TOP OF FIXTURE, UNO. FINISH BY ARCH.
D	SURFACE MOUNTED WRAPAROUND	4'L	COLUMBIA LIGHTING RLW4-35ML-FAW-EDU	FROSTED ACRYLIC	LED	0-10V DIMMING LED	129	40	UNV.	
Е	EXISTING TO REMAIN	-	-	-	-	-	-	-	-	
F	SURFACE MOUNTED STRIPLIGHT	4'L	COLUMBIA LIGHTING MPS4-35ML-CW-EDU	FROSTED ACRYLIC	LED	0-10V DIMMING LED	140	32	-	
G	CEILING RECESSED SHOWER DOWNLIGHT	4"Ø	PRESCOLITE LTR-4RD-H-SL-06-DM1 / LTR=4RD-T-SHSL35K8-WTAML	PRISM. ACRYLIC	LED	0-10V DIMMING LED	46	8	UNV.	
Н	WALL MOUNTED LINEAR	4'L	LITECONTROL 2L-W-AD-04-08*-ASYM-C*-35K-D030-D01-1C-UNV	ASYM. DIFFUSED ACRYLIC	LED	0-10V DIMMING LED	102	12	UNV.	FIXTURE TO BE MOUNTED AT 8'-0" AFF TO TOP OF FIXTURE, UNO. FINISH BY ARCH.
<b>Ø Ø</b>	EXIT SIGNAGE	-	DUAL-LITE EVEURW	-	RED LED	-	-	2	UNV.	REFER TO PLANS FOR MOUNTING & NUMBER OF FACES
4 <sub>EB</sub>	EMERGENCY BATTERY PACK	-	DUAL-LITE LZ15-03L-B	-	LED	-	-	10	120VAC/ 6VDC	
11	EMERGENCY REMOTE HEAD	-	DUAL-LITE LZR-*-B-06VDC-03L	-	LED	-	-	-	6VDC	REFER TO PLANS FOR NUMBER OF HEAD

# GENERAL ELECTRICAL DEMO NOTES:

1. ELECTRICIAN SHALL REVIEW ALL TRADE'S DRAWINGS. AREAS NOTED TO BE DEMOLISHED ARE SHOWN ON ARCHITECTURAL PLANS. THIS SHALL INCLUDE ALL ELECTRICAL DEVICES, FIXTURES AND/OR SWITCHGEAR. ALL EXISTING EQUIPMENT SHALL REMAIN ON EXISTING SURFACES UNLESS SPECIFICALLY NOTED OTHERWISE.

2. ALL EXPOSED RACEWAYS & CABLES, NO LONGER IN USE, SHALL BE REMOVED.

3. MAINTAIN, OR RESTORE IF INTERRUPTED BY REMOVALS OR IN PATH OF NEW CONSTRUCTION, ALL CONDUITS, BRANCH CIRCUITS, AND FEEDERS PASSING THROUGH AND SERVING UNDISTURBED AREAS (SHOWN OR NOT SHOWN).

4. ALL EXISTING CONDUITS STUBBED THROUGH FLOOR OR ROOF SERVING ITEMS TO BE REMOVED (SHOWN OR NOT SHOWN) AND NOT REQUIRED TO BE REUSED SHALL BE CUT OFF FLUSH WITH THE SLAB OR ROOF DECK AND SEALED.

5. IN ANY AREA REQUIRING THE PERFORMANCE OF ANY TRADES WORK, THIS CONTRACTOR SHALL CAREFULLY REMOVE AND STORE ANY ELECTRICAL ITEMS IN THE PATH OF WORK, REINSTALLING AND RECONNECTING SAME AS REQUIRED IN ACCORDANCE WITH THE PLANS AND/OR AS DIRECTED AFTER COMPLETION OF OTHER TRADES WORK IN THAT AREA.

6. ELECTRICAL CONTRACTOR SHALL PROVIDE OWNER WITH MANIFEST SUBMISSION RECORD OF DISPOSAL FOR ALL LIGHT FIXTURES CONTAINING BALLASTS WITH PCB'S AND MERCURY FLUORESCENT LAMPS.

# GENERAL ELECTRICAL NOTES:

1. ALL WORK SHALL BE INSTALLED IN A NEAT AND WORKMAN LIKE MANNER, RECTILINEAR TO BUILDING STRUCTURE, AND IN ACCORDANCE WITH ALL APPLICABLE CODES, INCLUDING, BUT NOT LIMITED TO NFPA 70, 90A, 101 AND DIRECTION OF AUTHORITY HAVING JURISDICTION.

2. EXACT LOCATION OF MECHANICAL EQUIPMENT THAT REQUIRES ELECTRICAL CONNECTION IS TO BE COORDINATED WITH THE MECHANICAL CONTRACTOR.

3. ELECTRICIAN SHALL REVIEW ALL TRADES CONTRACT DOCUMENTS, AND FIELD VERIFY, TO DETERMINE SPECIFIC MOUNTING LOCATIONS FOR ELECTRICAL EQUIPMENT AND CONDUIT.


4. COORDINATE ARRANGEMENT, MOUNTING, AND SUPPORT OF ELECTRICAL CONDUIT AND EQUIPMENT TO PROVIDE FOR EASE OF DISCONNECTING THE EQUIPMENT WITH MINIMUM INTERFERENCE TO OTHER INSTALLATIONS; TO ALLOW RIGHT OF WAY FOR PIPING INSTALLED AT A REQUIRED SLOPE; AND SO CONNECTING RACEWAYS WILL BE CLEAR OF OBSTRUCTIONS AND OF THE WORKING AND ACCESS SPACE OF OTHER EQUIPMENT.

5. ALL PENETRATIONS OF RATED CEILINGS, WALLS AND PARTITIONS SHALL BE SEALED WITH A U.L. LISTED AND APPROVED FIRE SEALANT MATERIAL TO MAINTAIN THE RATING OF THE SEPARATION.

# **ABBREVIATIONS**


FLOOR

Α	AMPERES	GND	GROUND
AFF	ABOVE FINISHED FLOOR	HP	HORSEPOWER, HEAT PUMP
AFG	ABOVE FINISHED GRADE	JB	JUNCTION BOX
ATS	AUTOMATIC TRANSFER SWITCH	KVA	KILO VOLT AMPS
BATT	BATTERY	KW	KILOWATT(S)
BHEC	BANGOR HYDRO ELECTRIC CO.	LTG	LIGHTING
BKR	BREAKER	MAX	MAXIMUM
BLDG	BUILDING	MIN	MINIMUM
CB	CIRCUIT BREAKER	N	NEW
CKT	CIRCUIT	OC	ON CENTER
CLG	CEILING	OS/OI	OWNER SUPPLIED, OWNER INSTALLED ITEM
CMP	CENTRAL MAINE POWER CO.	PAR	PARTIAL CIRCUIT
CT	CURRENT TRANSFORMER	PVC	POLYVINYL CHLORIDE
DN	DOWN	RECEP	RECEPTACLE
DWG	DRAWING	TEL	TELEPHONE
EMERG	EMERGENCY	TYP	TYPICAL
EMT	ELECTRICAL METALLIC TUBING	UG	UNDERGROUND
EQUIP	EQUIPMENT	V	VOLTS
FA	FIRE ALARM	W	WATTS
FAA	FIRE ALARM ANNUNCIATOR	WG	WIRE GUARD
FACP	FIRE ALARM CONTROL PANEL	WM	WIREMOLD
FA-PE	FIRE ALARM SYSTEM POWER EXTENDER	WP	WEATHERPROOF
FIN	FINISH, FINISHED		
	AFF AFG ATS BATT BHEC BKR BLDG CB CKT CLG CMP CT DN DWG EMERG EMT EQUIP FA FAA FACP FA-PE	AFF ABOVE FINISHED FLOOR AFG ABOVE FINISHED GRADE ATS AUTOMATIC TRANSFER SWITCH BATT BATTERY BHEC BANGOR HYDRO ELECTRIC CO. BKR BREAKER BLDG BUILDING CB CIRCUIT BREAKER CKT CIRCUIT CLG CEILING CMP CENTRAL MAINE POWER CO. CT CURRENT TRANSFORMER DN DOWN DWG DRAWING EMERG EMERGENCY EMT ELECTRICAL METALLIC TUBING EQUIP EQUIPMENT FA FIRE ALARM FAA FIRE ALARM ANNUNCIATOR FACP FIRE ALARM SYSTEM POWER EXTENDER	AFF ABOVE FINISHED FLOOR HP AFG ABOVE FINISHED GRADE JB ATS AUTOMATIC TRANSFER SWITCH KVA BATT BATTERY KW BHEC BANGOR HYDRO ELECTRIC CO. LTG BKR BREAKER MAX BLDG BUILDING MIN CB CIRCUIT BREAKER N CKT CIRCUIT OC CLG CEILING OS/OI CMP CENTRAL MAINE POWER CO. PAR CT CURRENT TRANSFORMER PVC DN DOWN RECEP DWG DRAWING TEL EMERG EMERGENCY TYP EMT ELECTRICAL METALLIC TUBING UG EQUIP EQUIPMENT V FA FIRE ALARM NOUNCIATOR WG FACP FIRE ALARM SYSTEM POWER EXTENDER WW

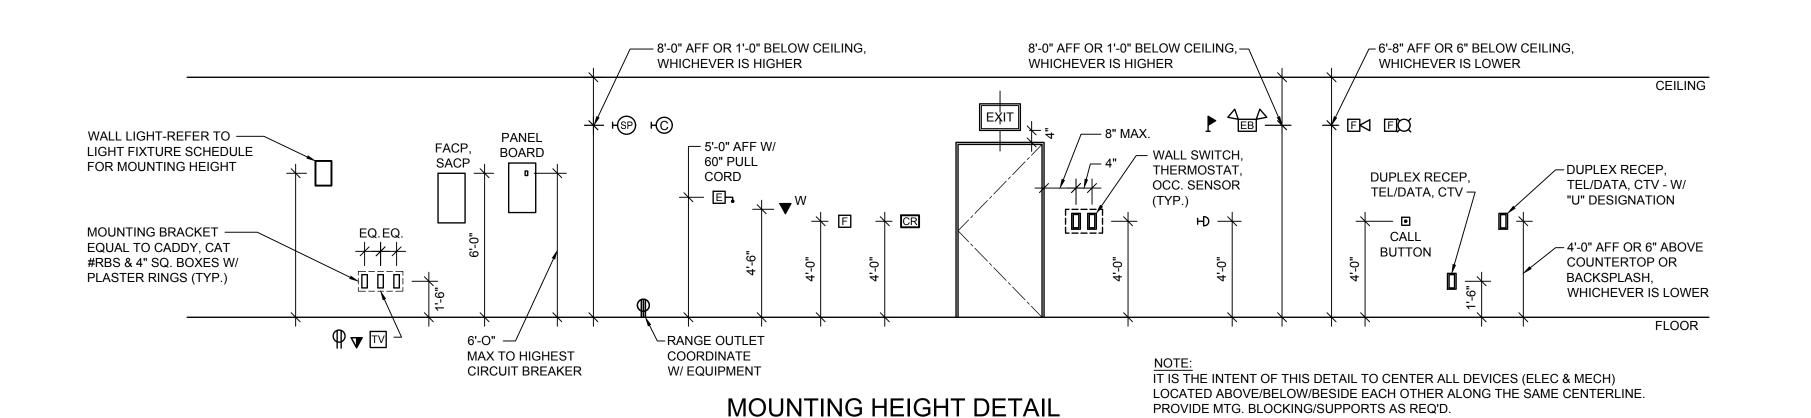

NOT TO SCALE

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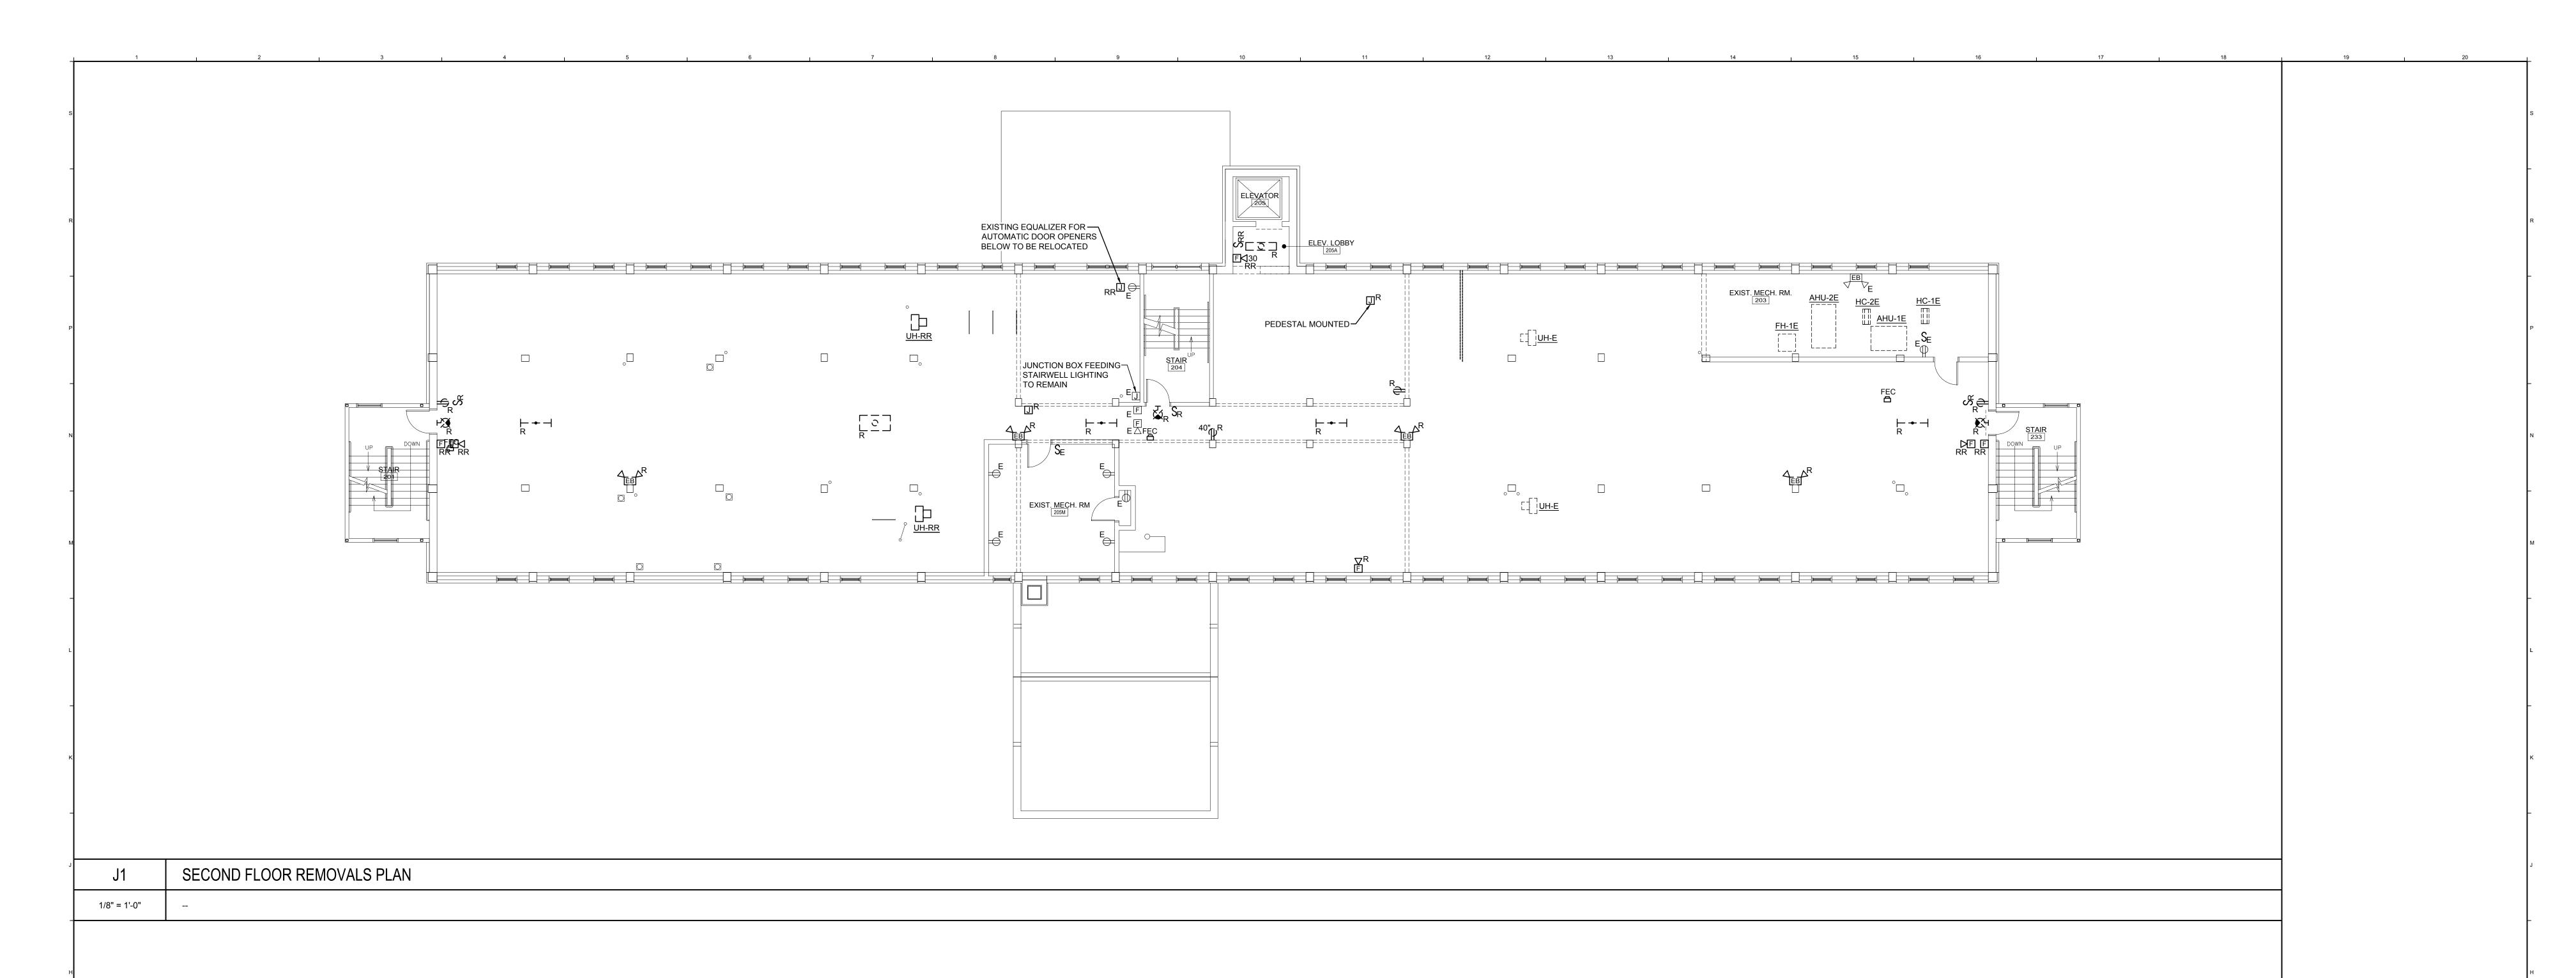
UMA BANGOR CAMDEN HALL SECOND FLOOR RENOVATION

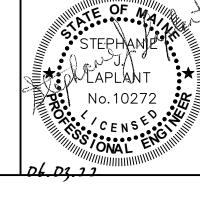
BANGOR, ME ELECTRICAL LEGEND & LIGHT FIXTURE SCHEDULE


10089002 - E-001 10089002 GRAPHIC SCALE:

AS NOTED KCK/JLR SHEET NO

E-001



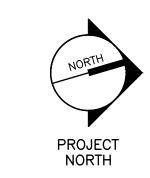

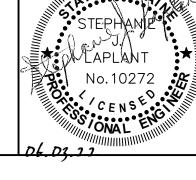

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UMA BANGOR CAMDEN HALL SECOND FLOOR RENOVATION


BANGOR, ME SECOND FLOOR REMOVALS PLAN


10089002 - ED102 10089002 GRAPHIC SCALE:

AS NOTED KCK/JLR SHEET No.

KRM
SJL


ED102

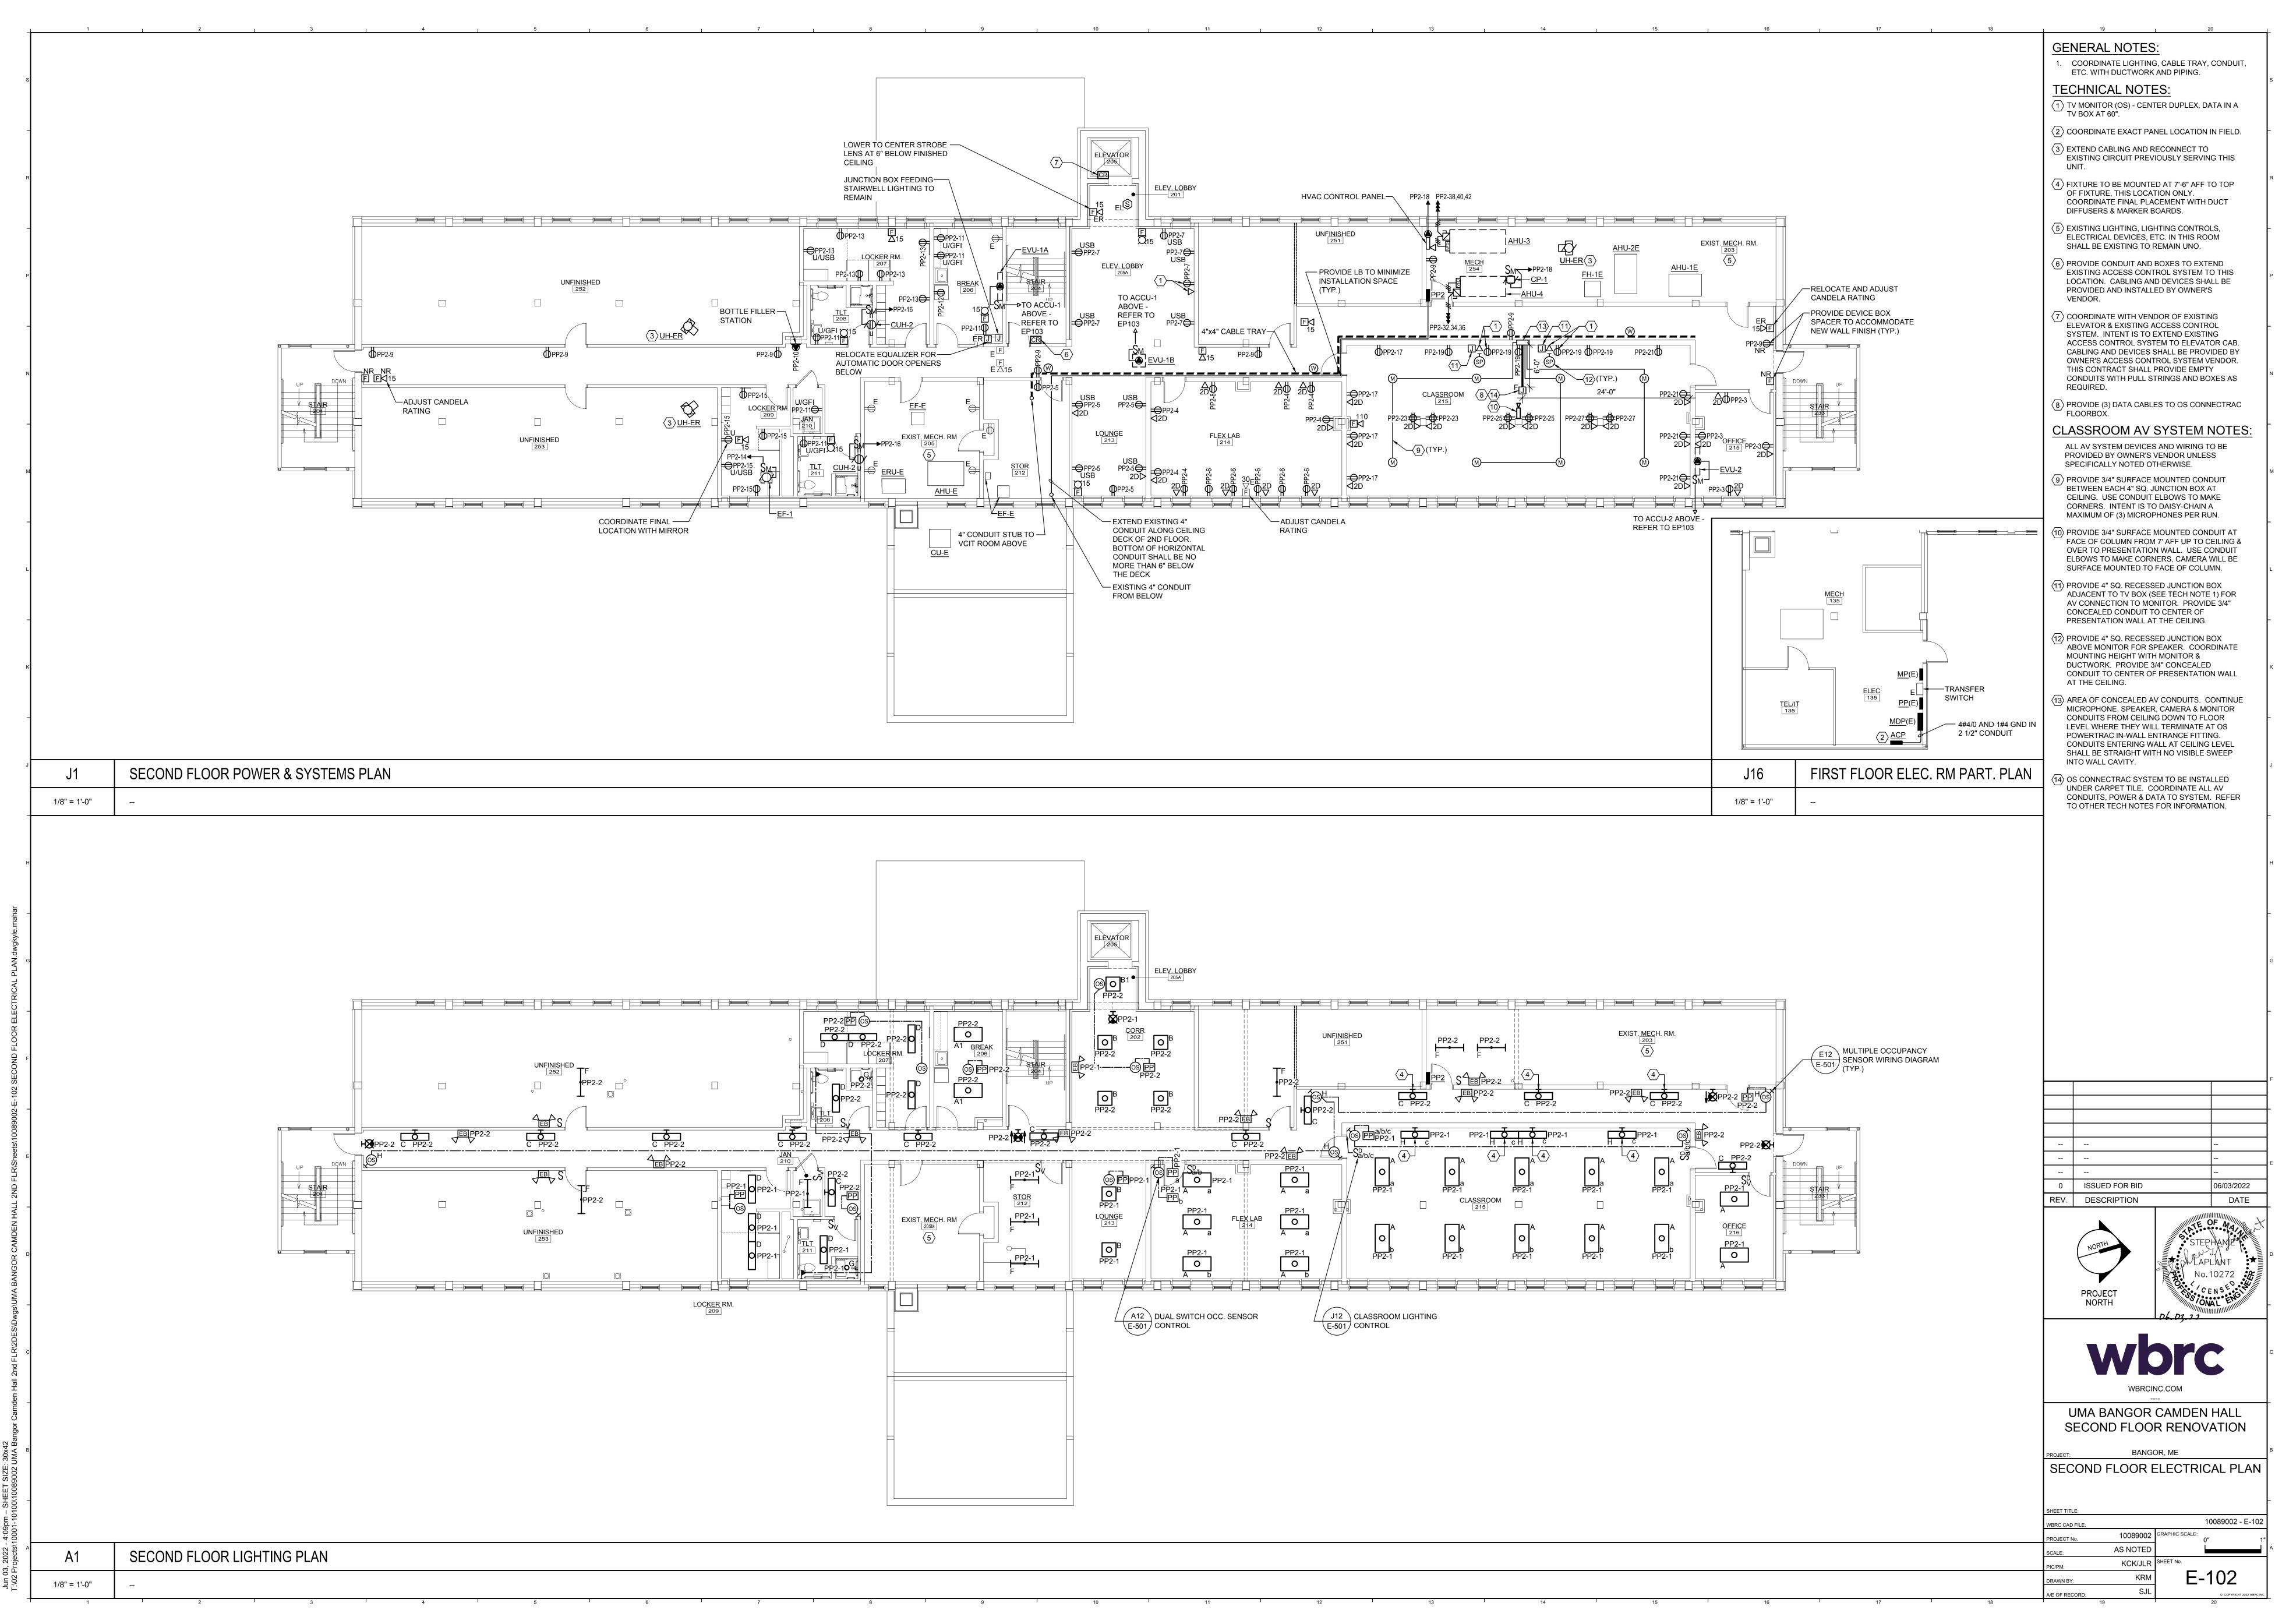


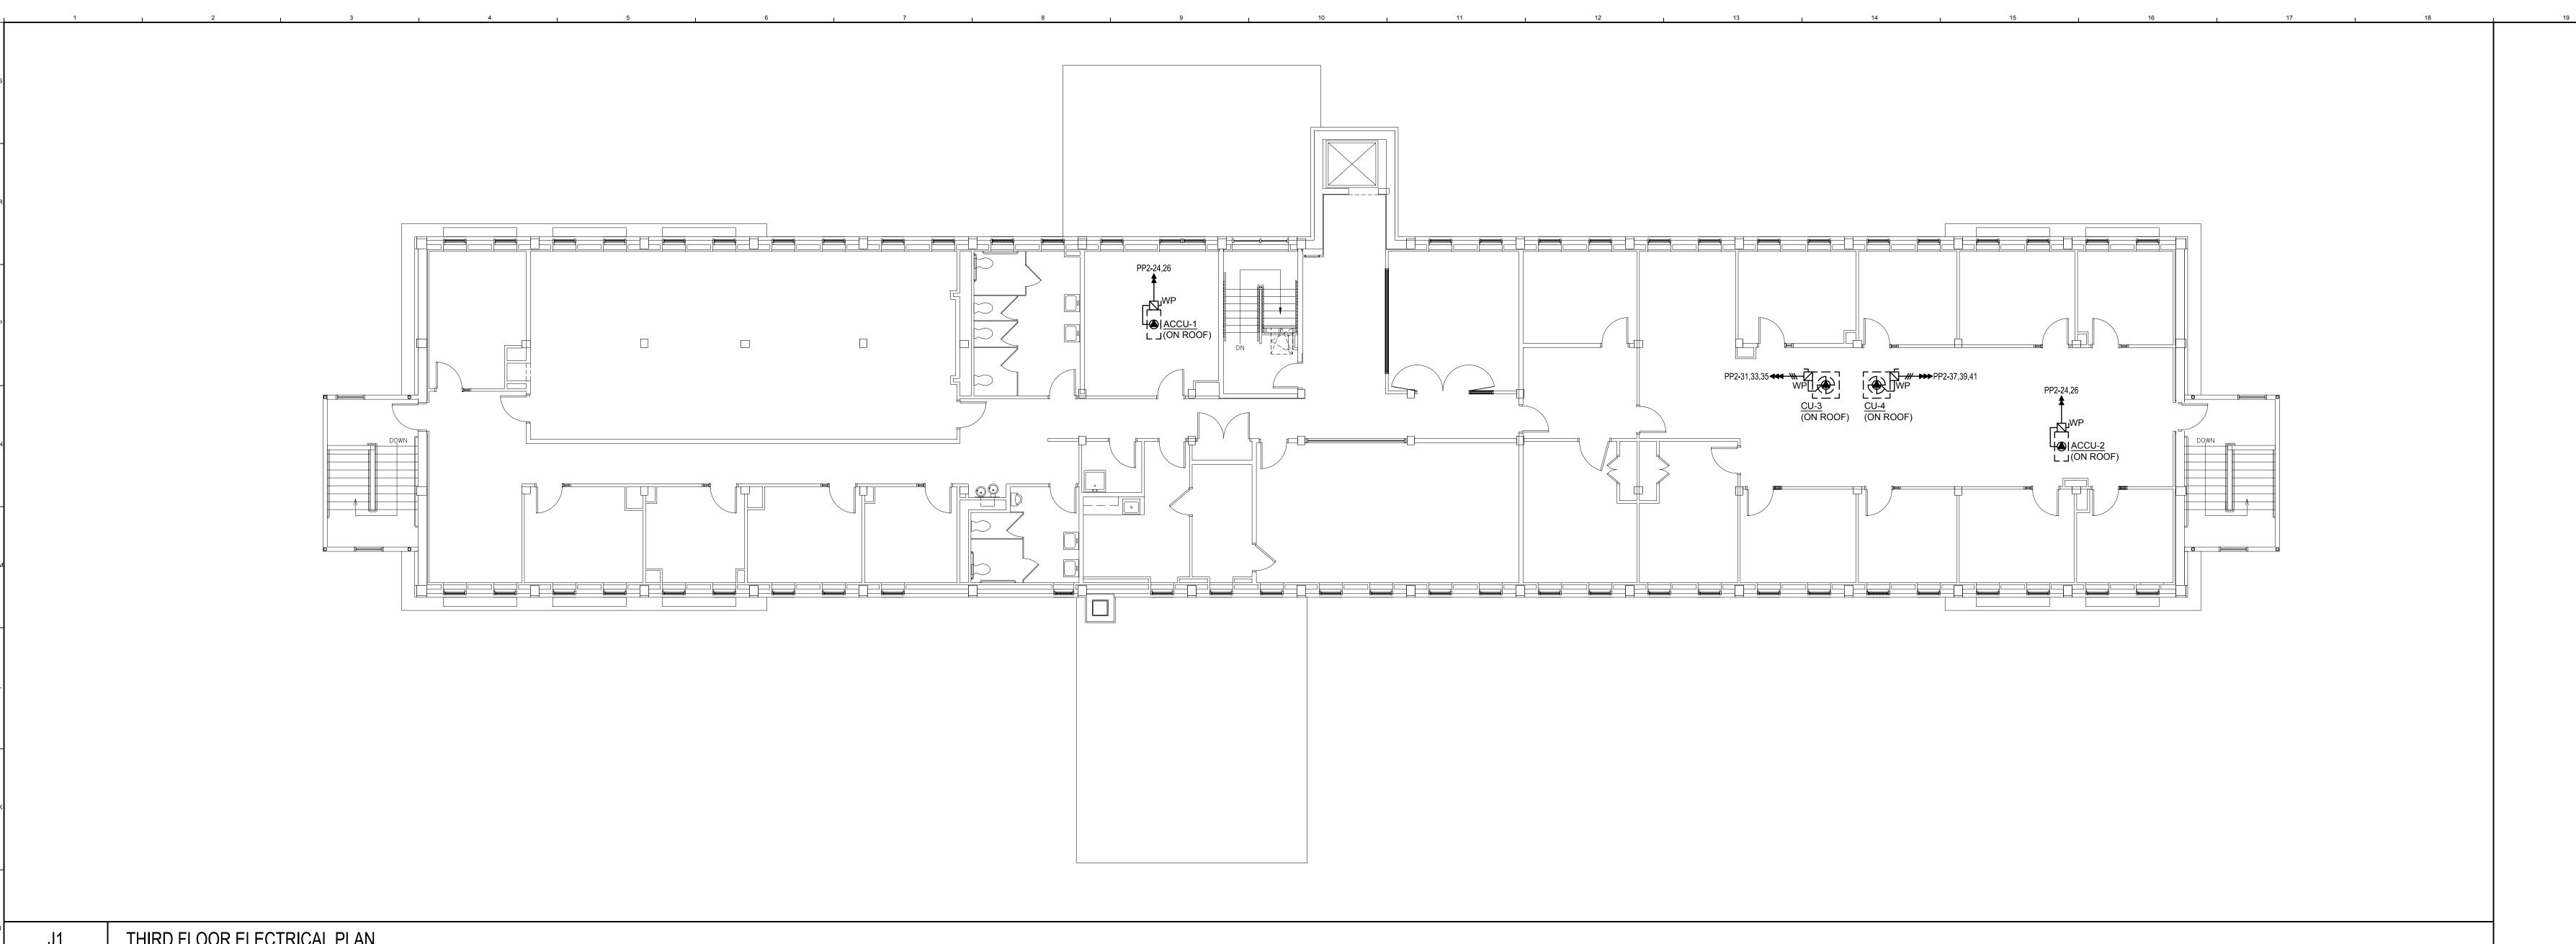

THIRD FLOOR ELECTRICAL PLAN 1/8" = 1'-0"

> 0 ISSUED FOR BID 06/03/2022 REV. DESCRIPTION

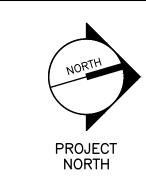

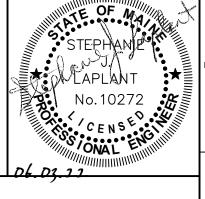

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UMA BANGOR CAMDEN HALL SECOND FLOOR RENOVATION

BANGOR, ME THIRD FLOOR ELECTRICAL PLAN

10089002 - E-103 10089002 GRAPHIC SCALE: AS NOTED

KCK/JLR SHEET No.
KRM
SJL

E-103

